


engborc3.dgn (BORDEF) JULY 2, 2013



PLAN
STA 12+920 TO STA 13+280
1 G310

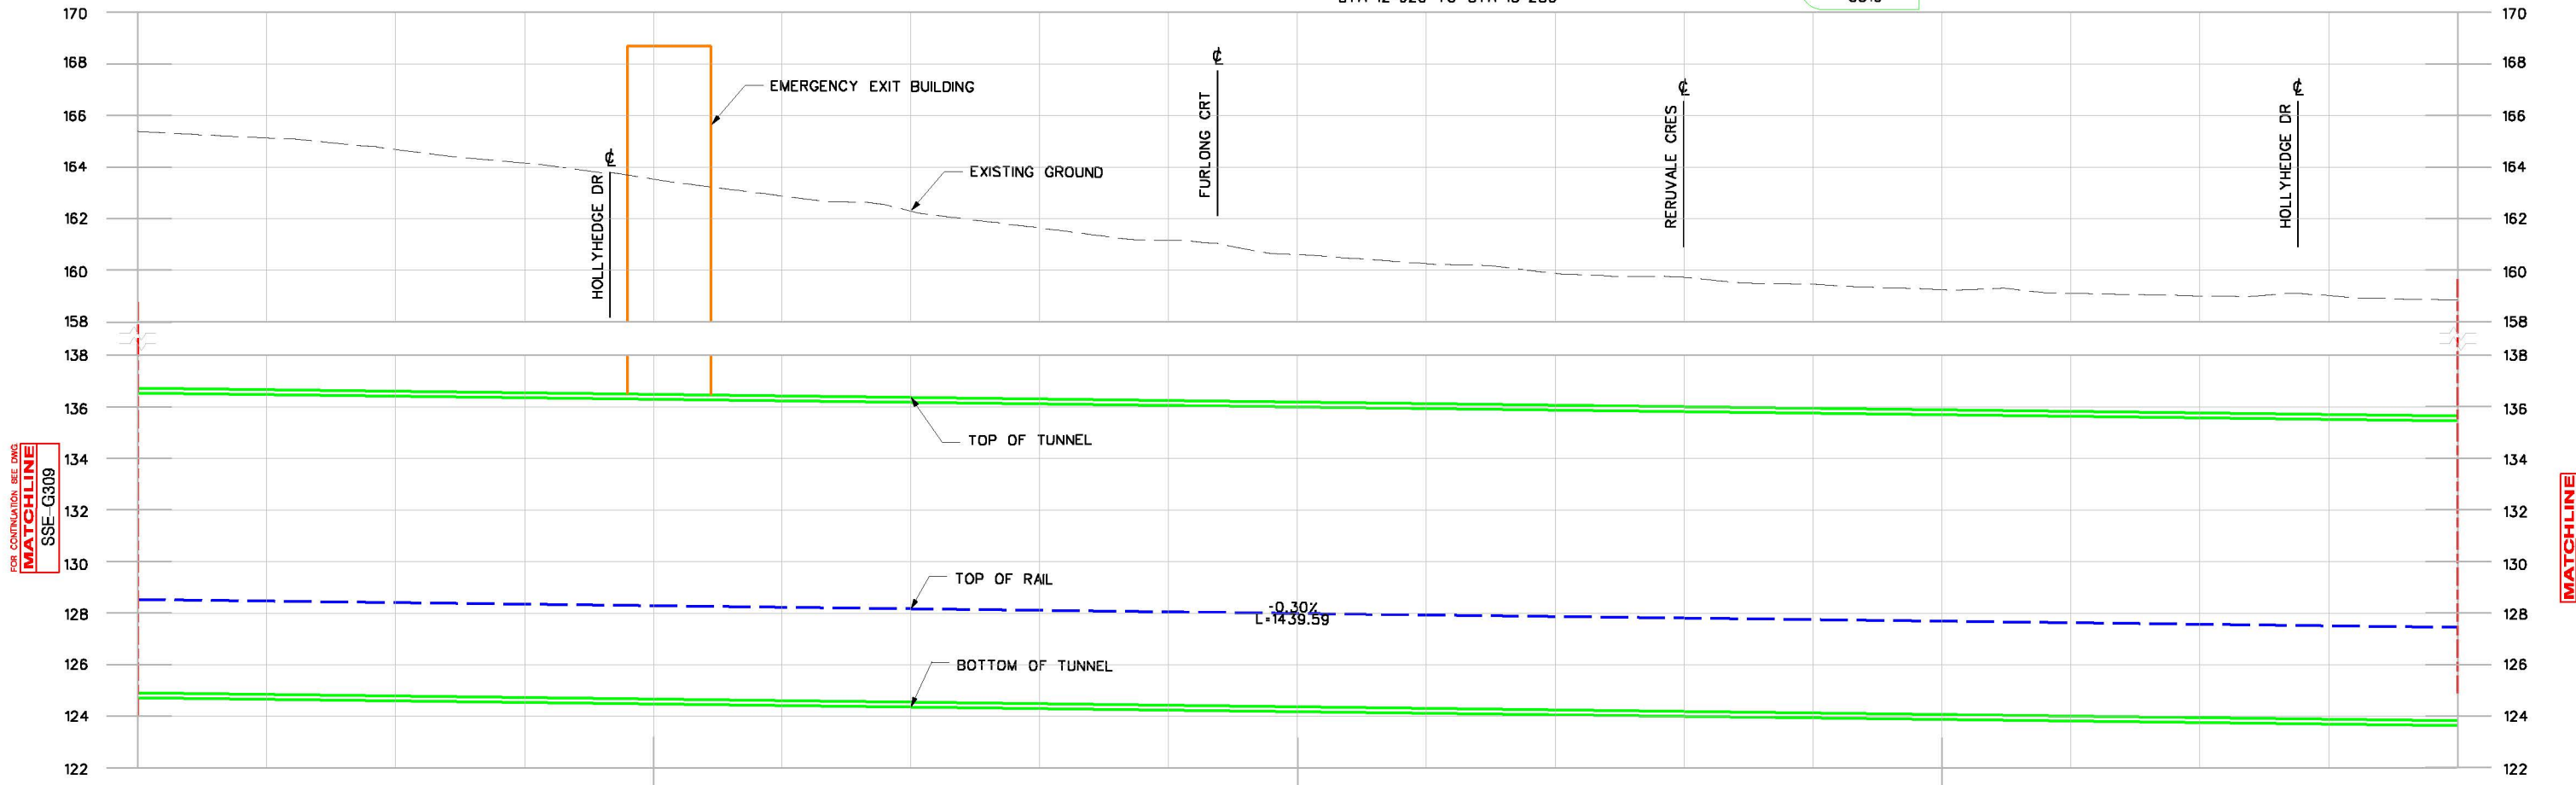

ELEVATION
STA 12+920 TO STA 13+280
1 G310

BUDG. REF. No.

FILENAME:

SHEET No.

DRAWING No.

REVISIONS

LEGEND	
	STRUCTURE
	ALIGNMENT ϕ
	NEW TTC RIGHT-OF-WAY
	TRACK ϕ
	EXISTING PROPERTY LINE
	EMERGENCY EXIT BUILDING (EEB)
	TRACTION POWER SUBSTATION



CONCEPTUAL DESIGN
NOT FOR CONSTRUCTION

DRAWN	L. LI	2017/02/28
CHECKED	D.FANG	2017/02/28
CORRECT	D.FANG	2017/02/28
SCALE		

SCARBOROUGH SUBWAY EXTENSION EA
PLAN AND PROFILE
STA 12+920 TO STA 13+280

Plot Date:	3/9/2017
TORONTO TRANSIT COMMISSION ENGINEERING DEPARTMENT	
Dwg. No.	SSE-G310
Sheet No.	


engborc3.dgn (BORDEF) JULY 2, 2013

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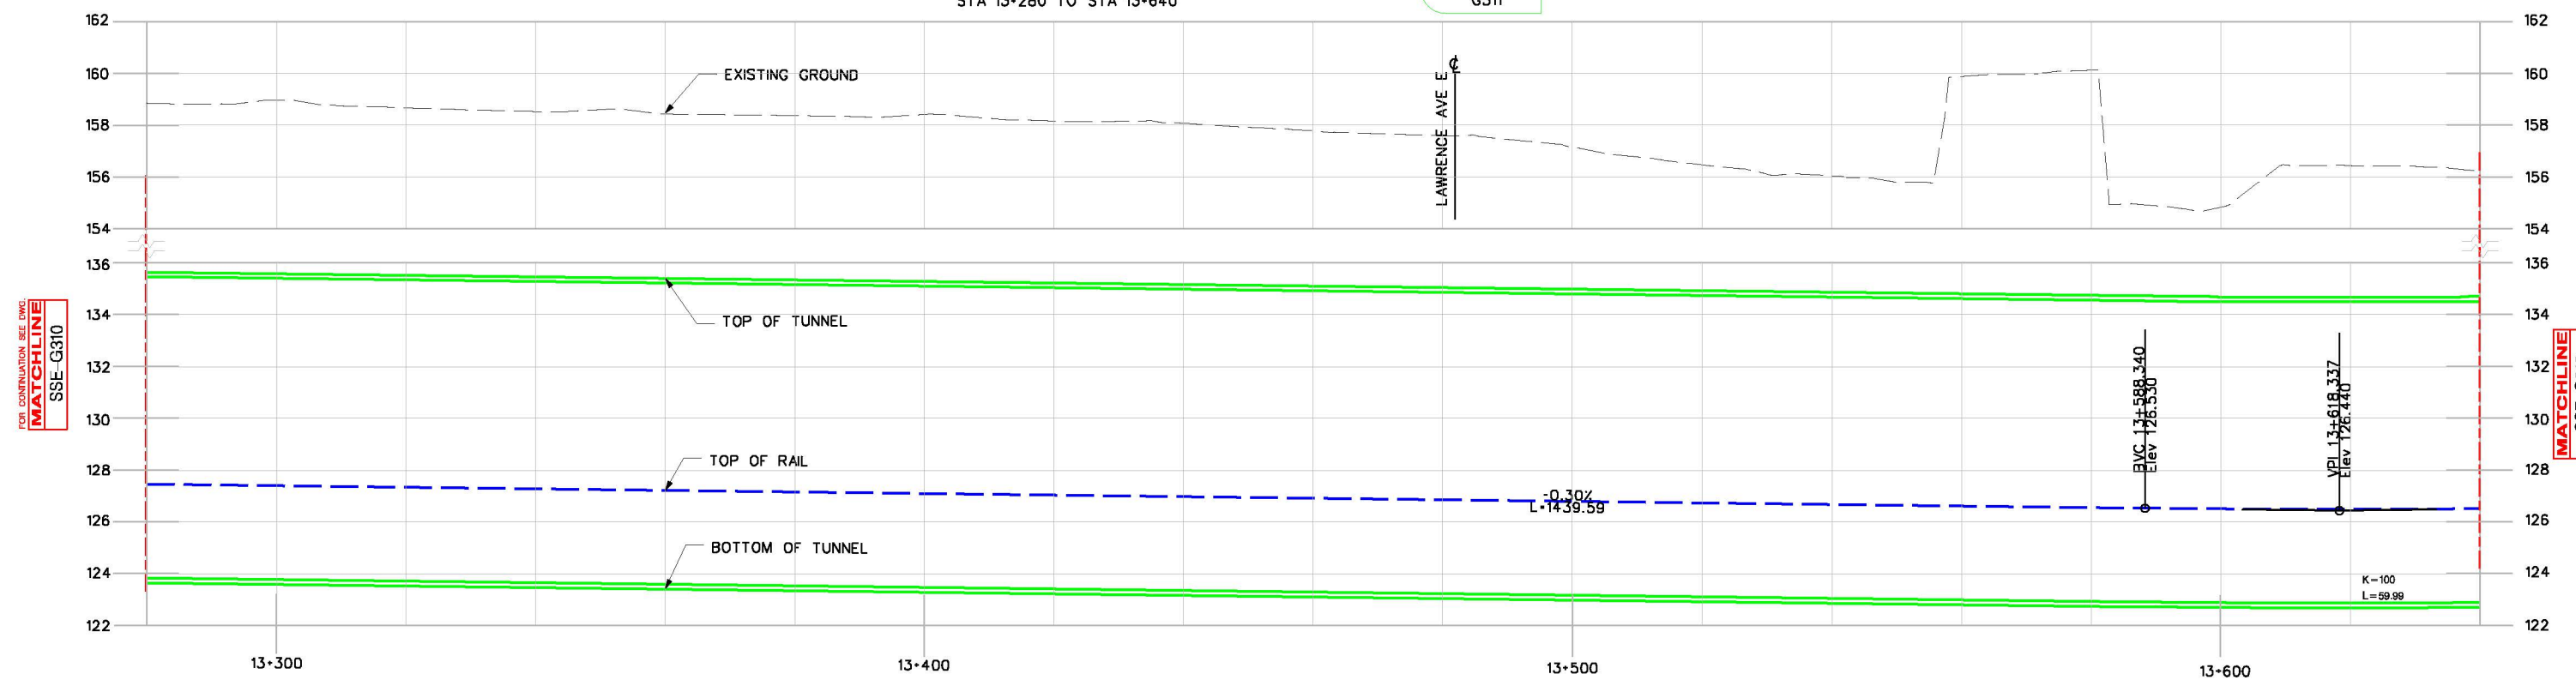
FILENAME:

SHEET No.

DRAWING No.

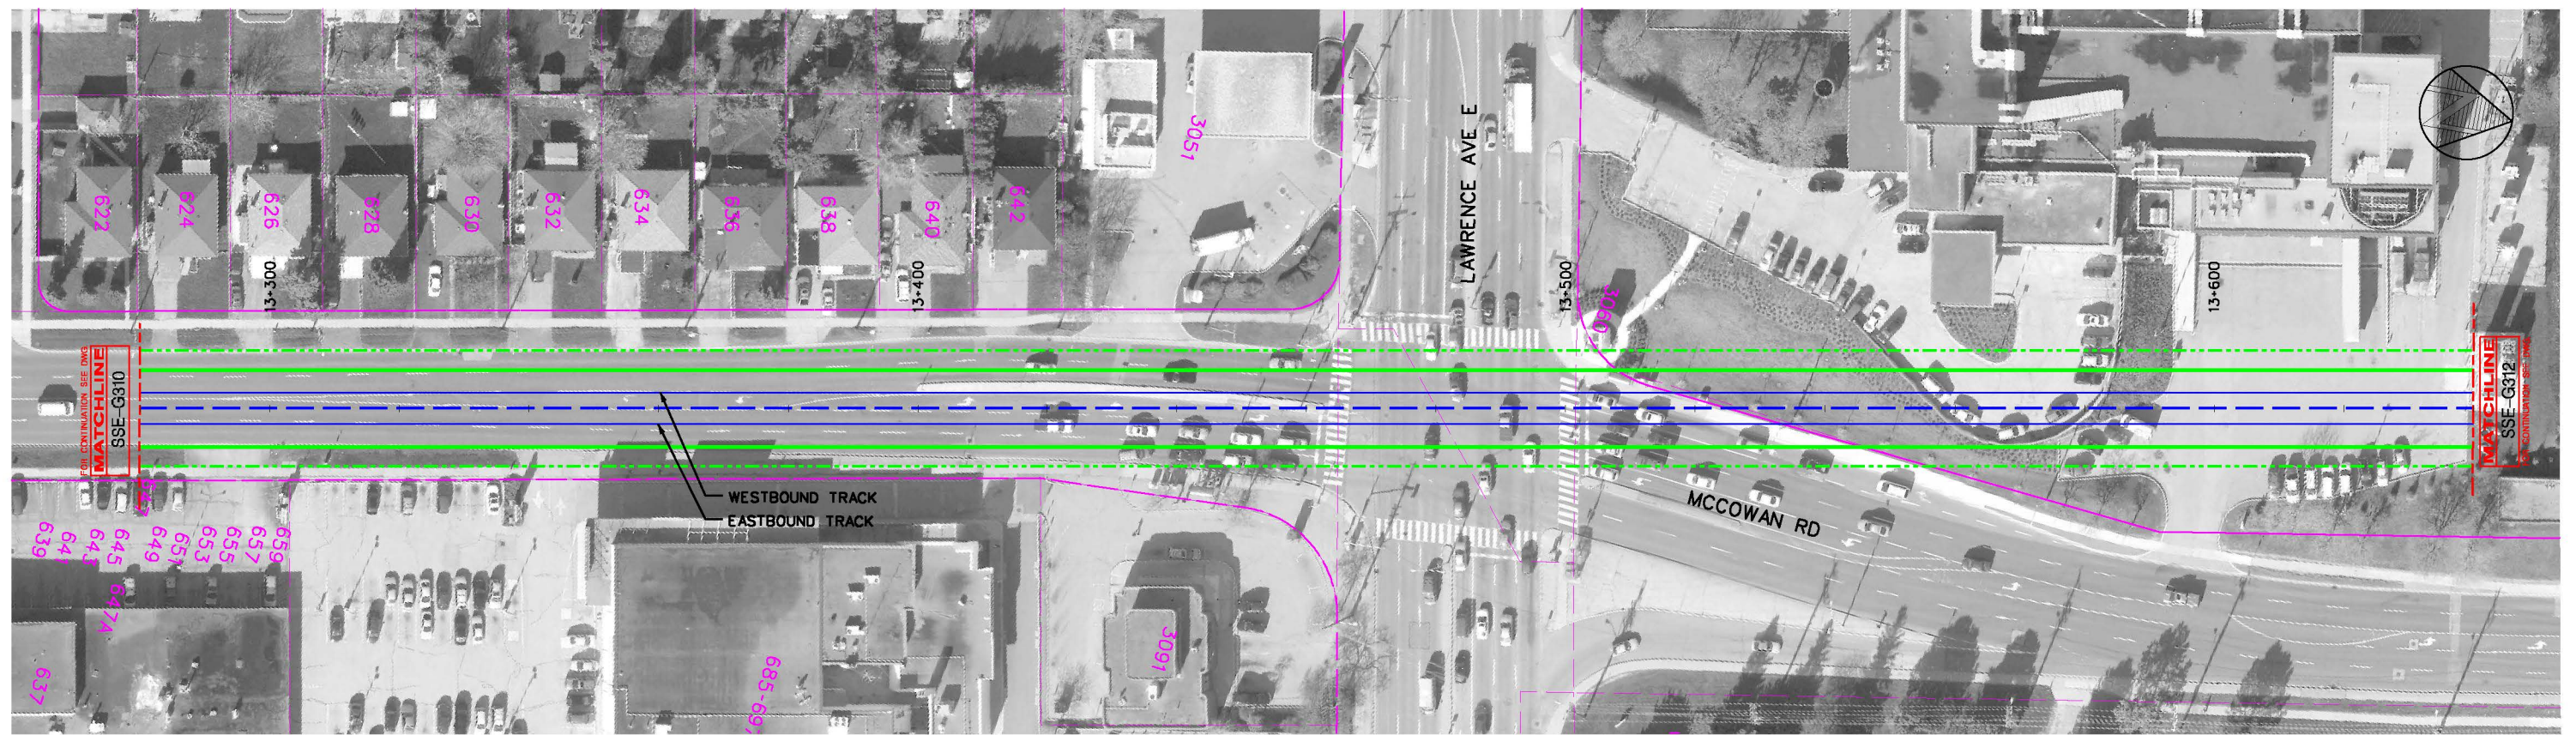

PLAN
STA 13+280 TO STA 13+640



ELEVATION
STA 13+280 TO STA 13+640

REVISIONS

LEGEND	
	STRUCTURE
	ALIGNMENT ϕ
	NEW TTC RIGHT-OF-WAY
	TRACK ϕ
	EXISTING PROPERTY LINE
	EMERGENCY EXIT BUILDING (EEB)
	TRACTION POWER SUBSTATION



CONCEPTUAL DESIGN
NOT FOR CONSTRUCTION

DRAWN	L. LI	2017/02/28
CHECKED	D. FANG	2017/02/28
CORRECT	D. FANG	2017/02/28
SCALE		

SCARBOROUGH SUBWAY EXTENSION EA
PLAN AND PROFILE
STA 13+280 TO STA 13+640

Plot Date:	3/9/2017
TORONTO TRANSIT COMMISSION ENGINEERING DEPARTMENT	
Dwg. No.	SSE-G311
Sheet No.	


ENGINEER: J. BORDERS JULY 2, 2015

BLDG. REF. No.

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SHEET No.


DRAWING No.

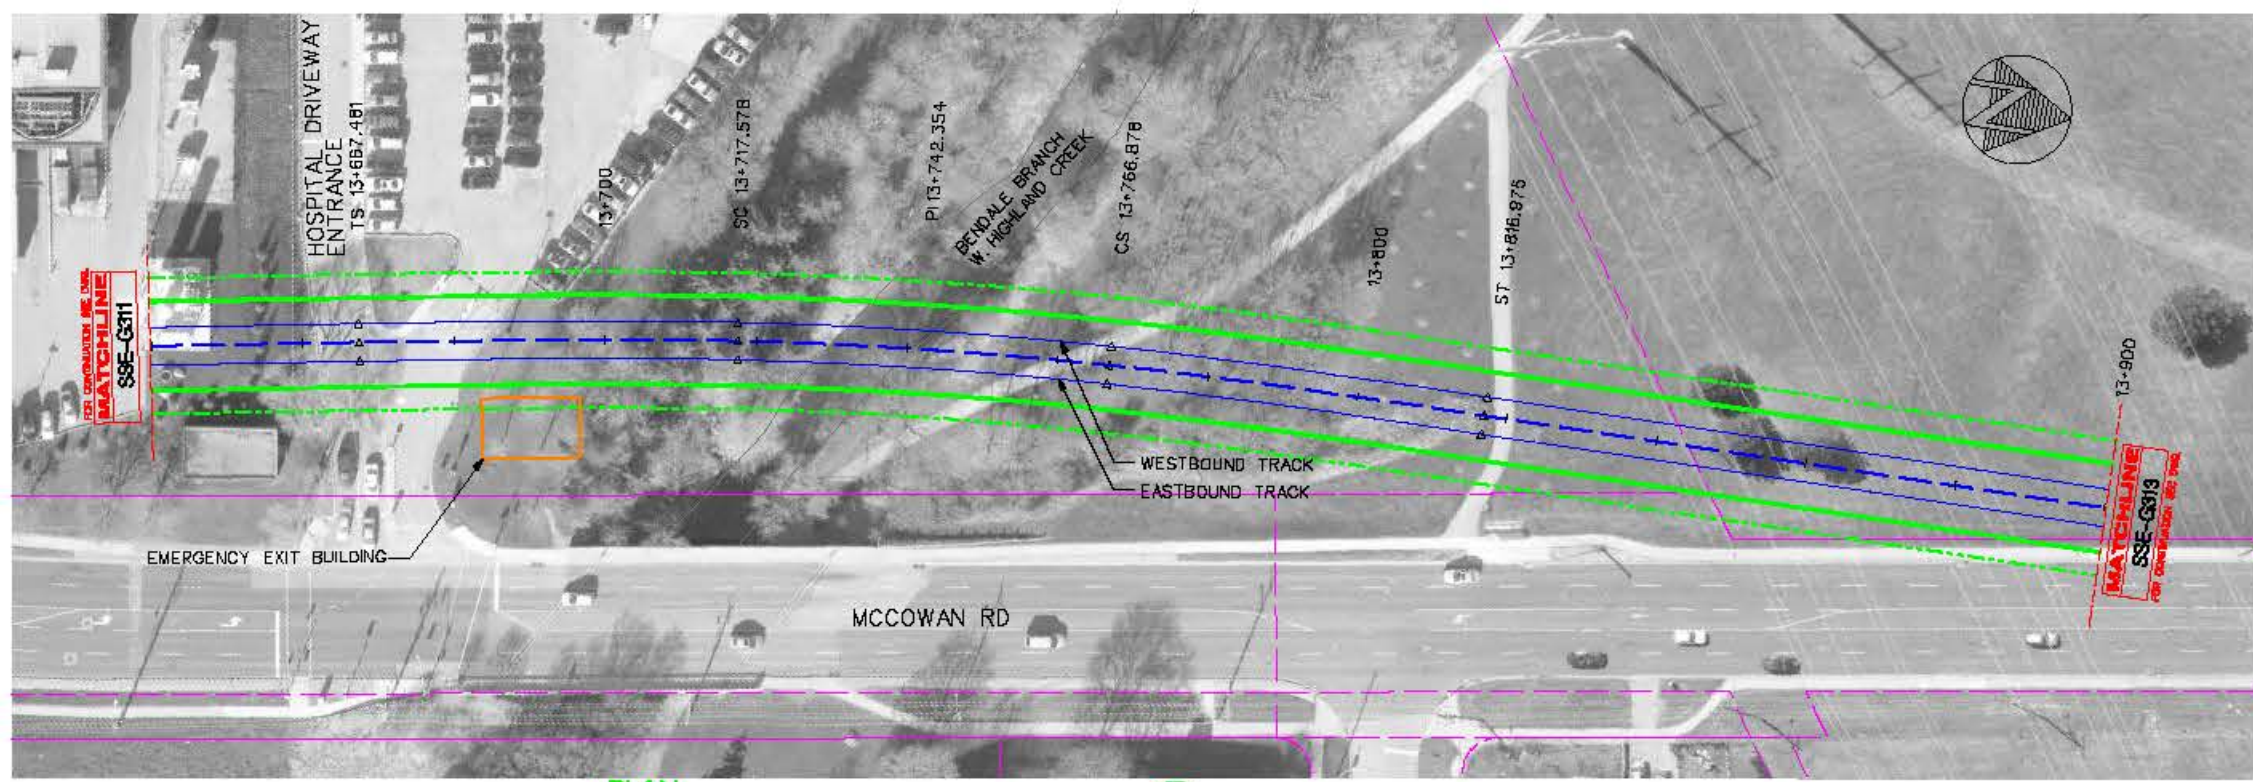

PLAN

STA 13+640 TO STA 13+900

1
G312

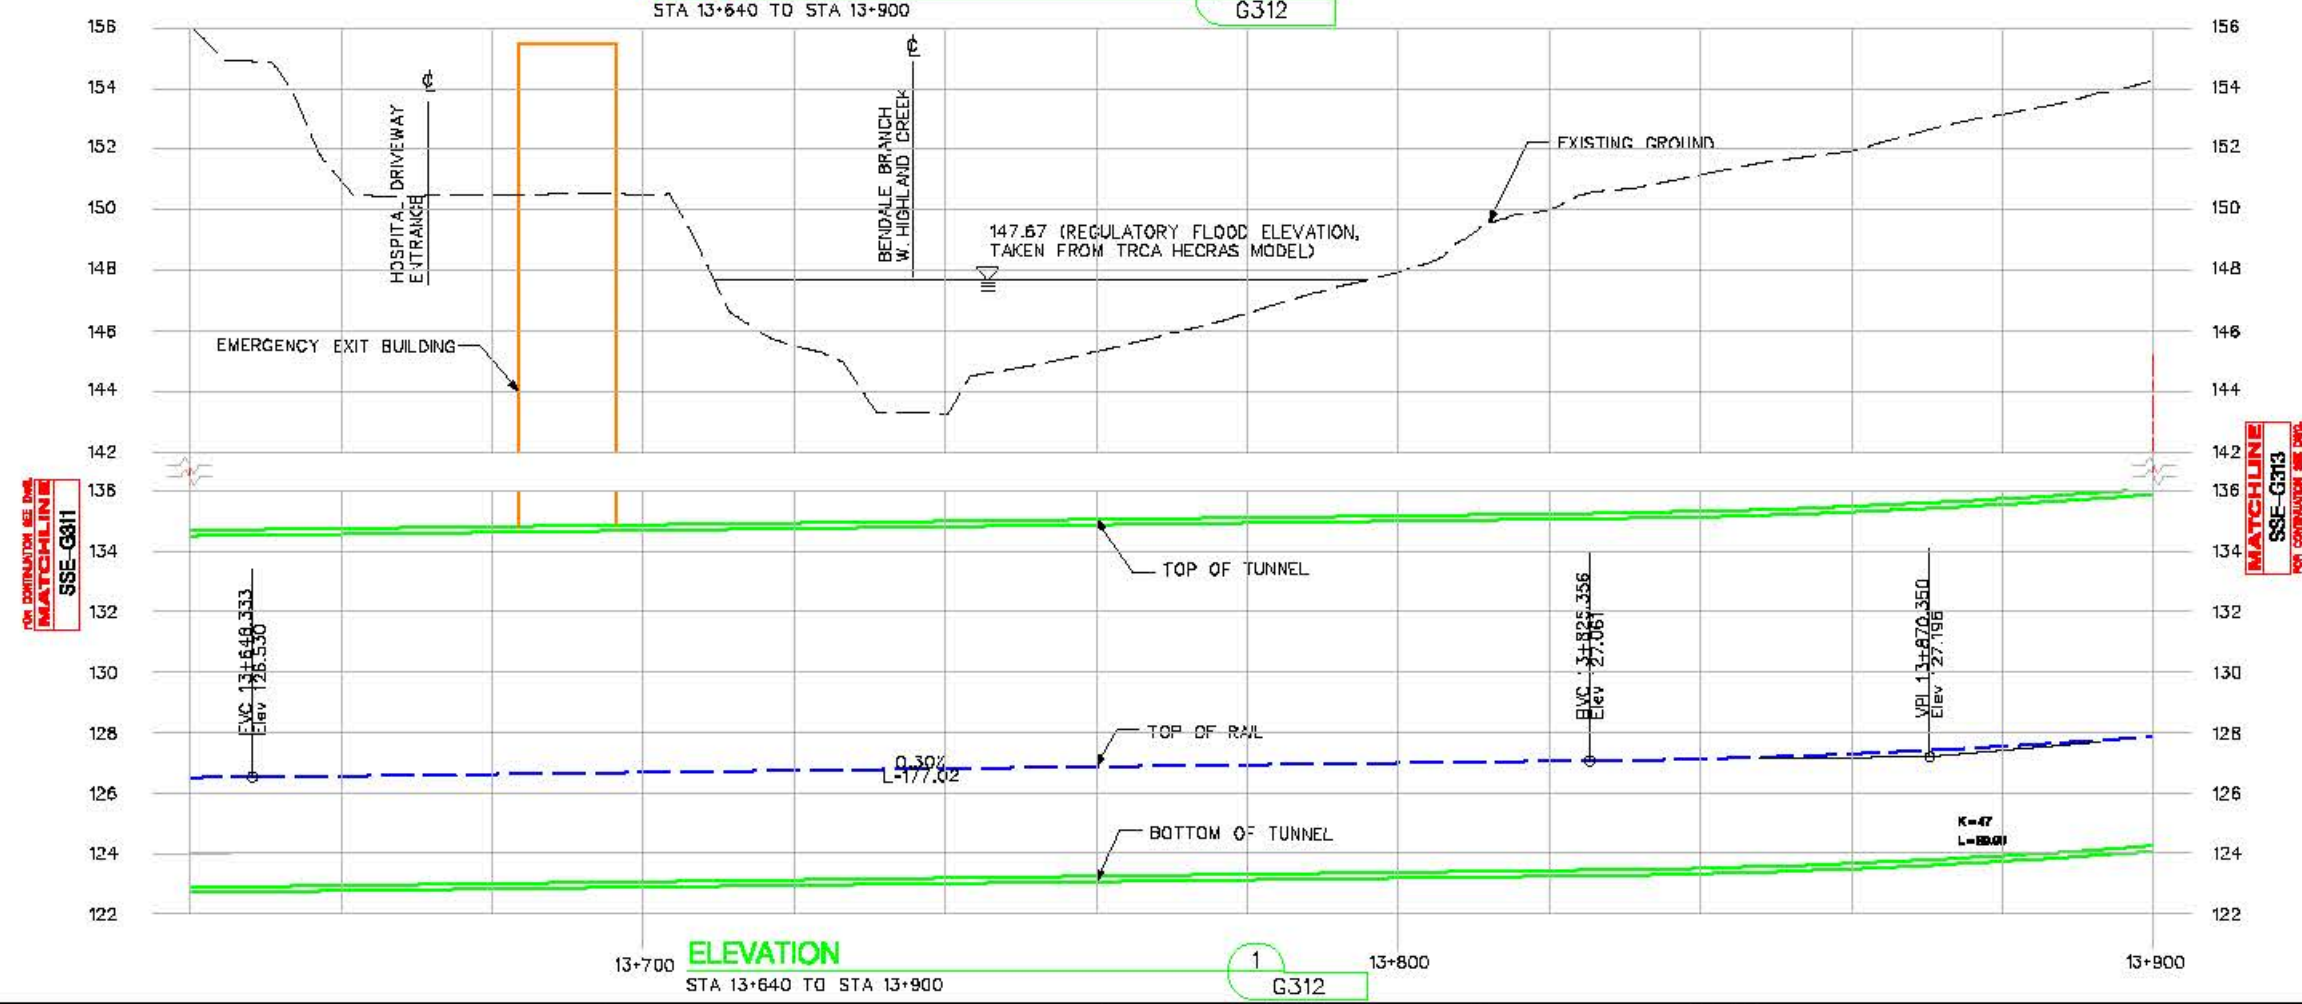

ELEVATION

STA 13+640 TO STA 13+900

1
G312

REVISIONS

LEGEND	
	STRUCTURE
	ALIGNMENT ϕ
	NEW TTC RIGHT-OF-WAY
	TRACK ϕ
	EXISTING PROPERTY LINE
	EMERGENCY EXIT BUILDING (EEB)
	TRACTION POWER SUBSTATION




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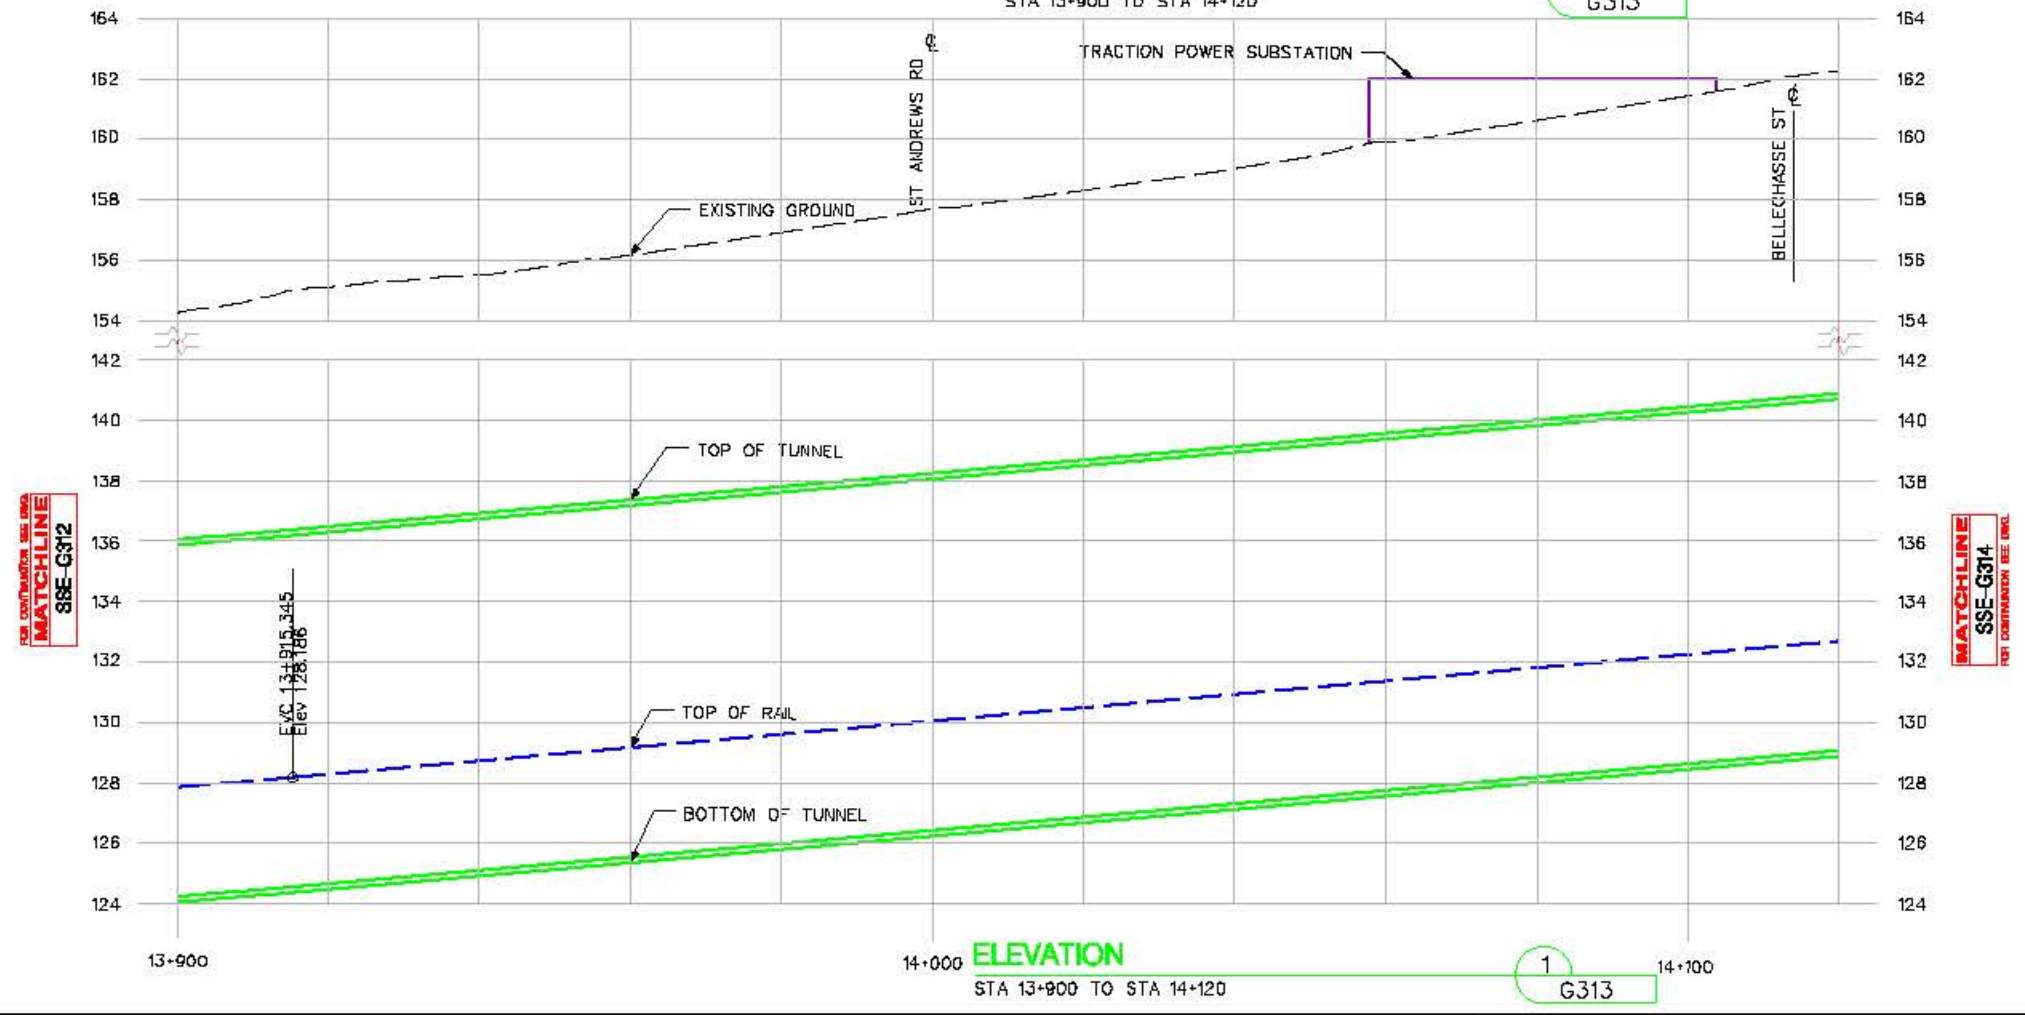
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CHECKED: D.F.ANG	2017/02/28
CORRECT: D.F.ANG	2017/02/28
SCALE: HOR 1"=100'	VER 1"=250'

SCARBOROUGH SUBWAY EXTENSION EA
PLAN AND PROFILE
STA 13+640 TO STA 13+800

File Date: 7/29/2017
TORONTO TRANSIT COMMISSION ENGINEERING DEPARTMENT
Draw. No. SSE-G312
Sheet No.

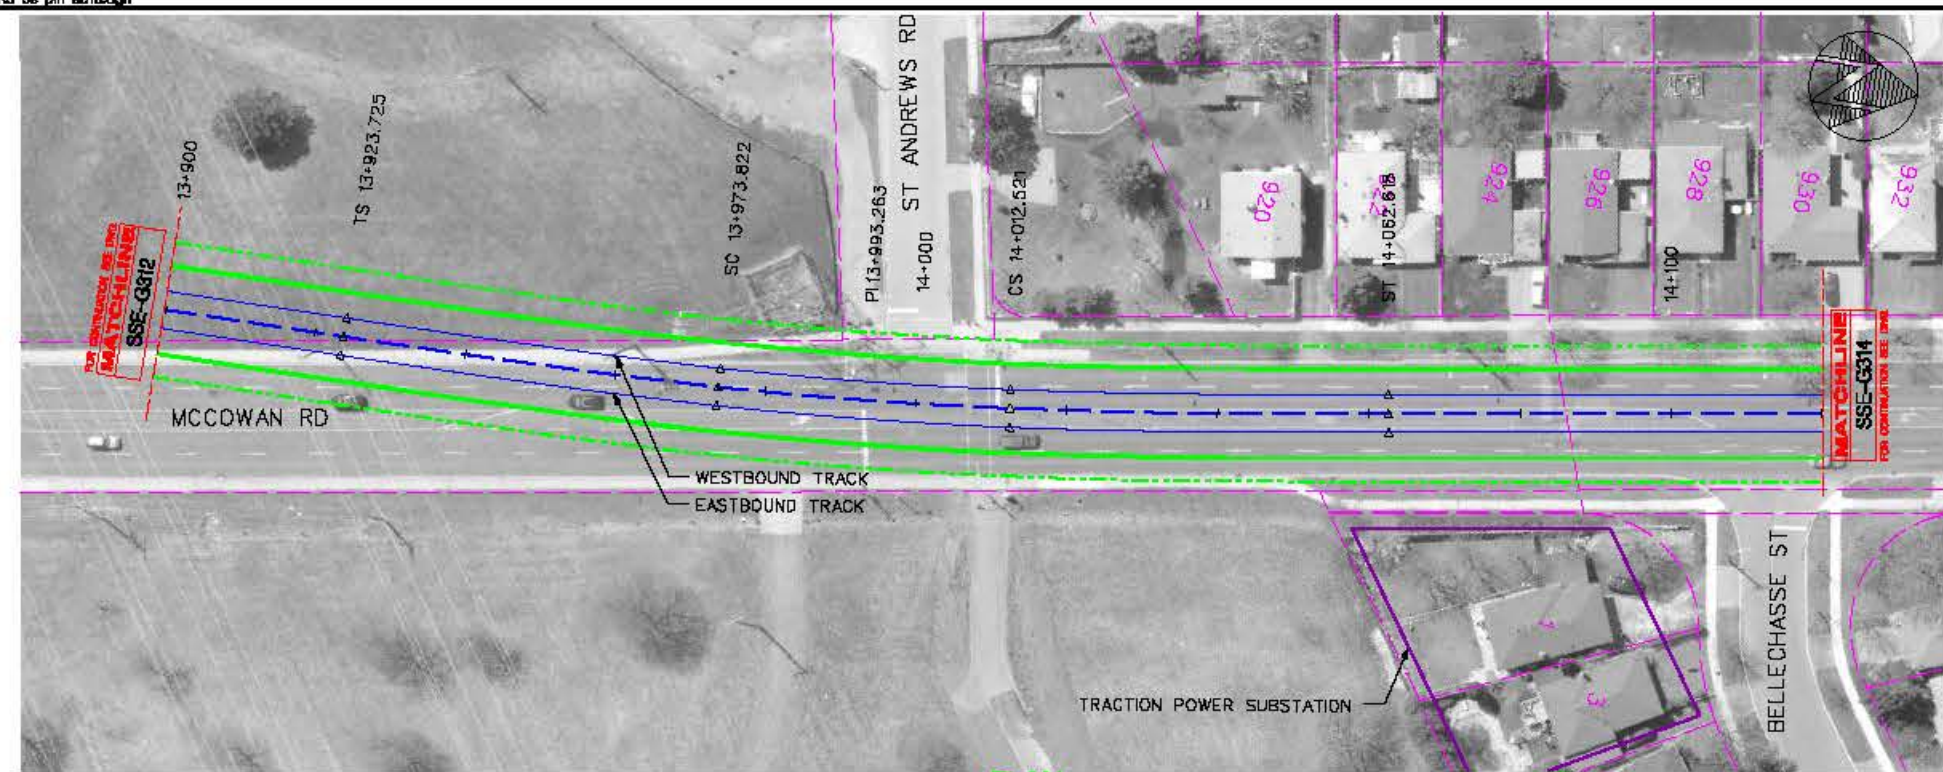

PLAN
STA 13+900 TO STA 14+120
1 G313



ELEVATION
STA 13+900 TO STA 14+120
1 G313

REVISIONS	LEGEND																				
	<table border="0"> <tr> <td></td> <td>STRUCTURE</td> <td></td> <td>EMERGENCY EXIT BUILDING (EEB)</td> </tr> <tr> <td></td> <td>ALIGNMENT</td> <td></td> <td>TRACTION POWER SUBSTATION</td> </tr> <tr> <td></td> <td>NEW TTC RIGHT-OF-WAY</td> <td></td> <td></td> </tr> <tr> <td></td> <td>TRACK</td> <td></td> <td></td> </tr> <tr> <td></td> <td>EXISTING PROPERTY LINE</td> <td></td> <td></td> </tr> </table>		STRUCTURE		EMERGENCY EXIT BUILDING (EEB)		ALIGNMENT		TRACTION POWER SUBSTATION		NEW TTC RIGHT-OF-WAY				TRACK				EXISTING PROPERTY LINE		
	STRUCTURE		EMERGENCY EXIT BUILDING (EEB)																		
	ALIGNMENT		TRACTION POWER SUBSTATION																		
	NEW TTC RIGHT-OF-WAY																				
	TRACK																				
	EXISTING PROPERTY LINE																				





CONCEPTUAL DESIGN
NOT FOR CONSTRUCTION

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CHECKED	D.F.ANG	2017/02/28	
CORRECT	D.F.ANG	2017/02/28	
SCALE	HOR	0 10 20 30 40 50	1:1000
VER		0 2 4 6 8	1:250

SCARBOROUGH SUBWAY EXTENSION EA
PLAN AND PROFILE
STA 13+800 TO STA 14+120

File Date	7/20/2017
TORONTO TRANSIT COMMISSION ENGINEERING DEPARTMENT	
Dep. No.	SSE-G313
Sheet No.	

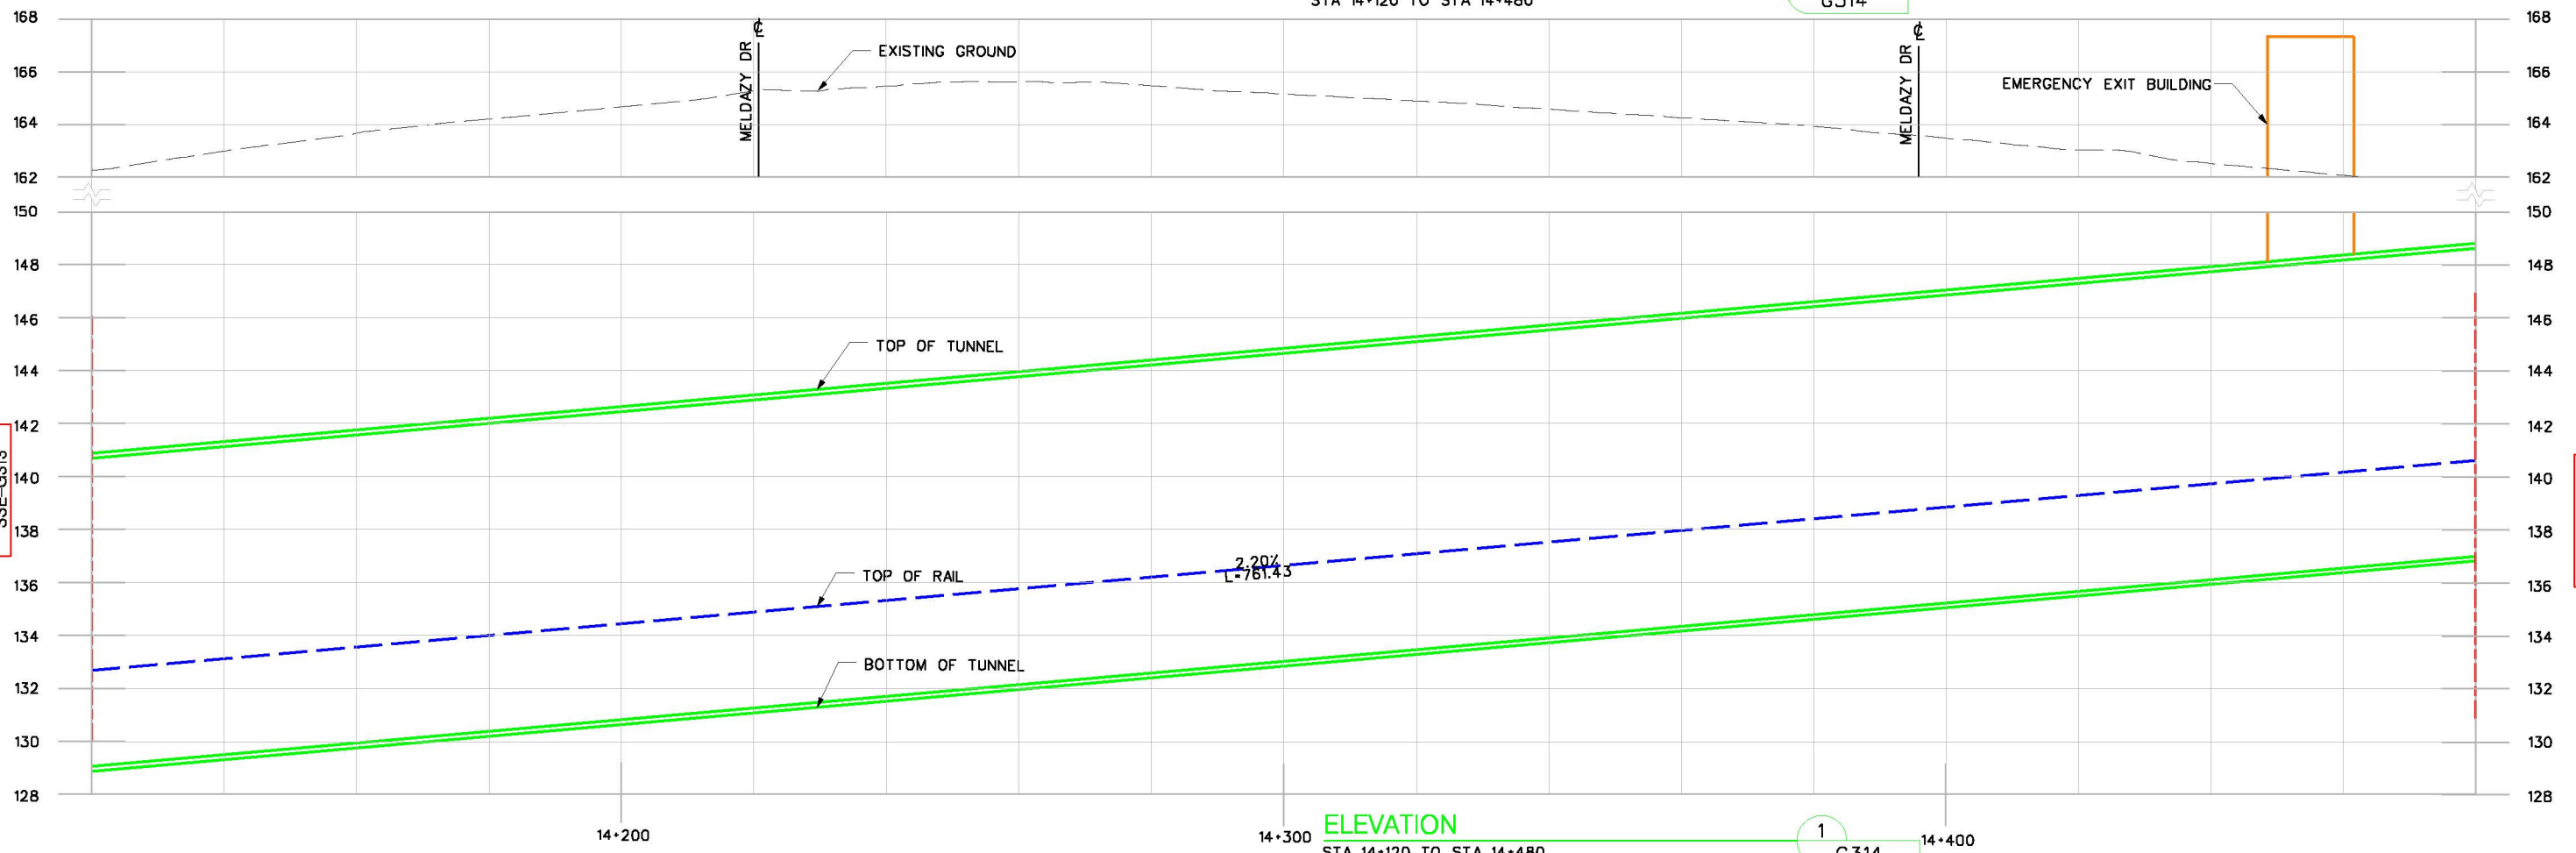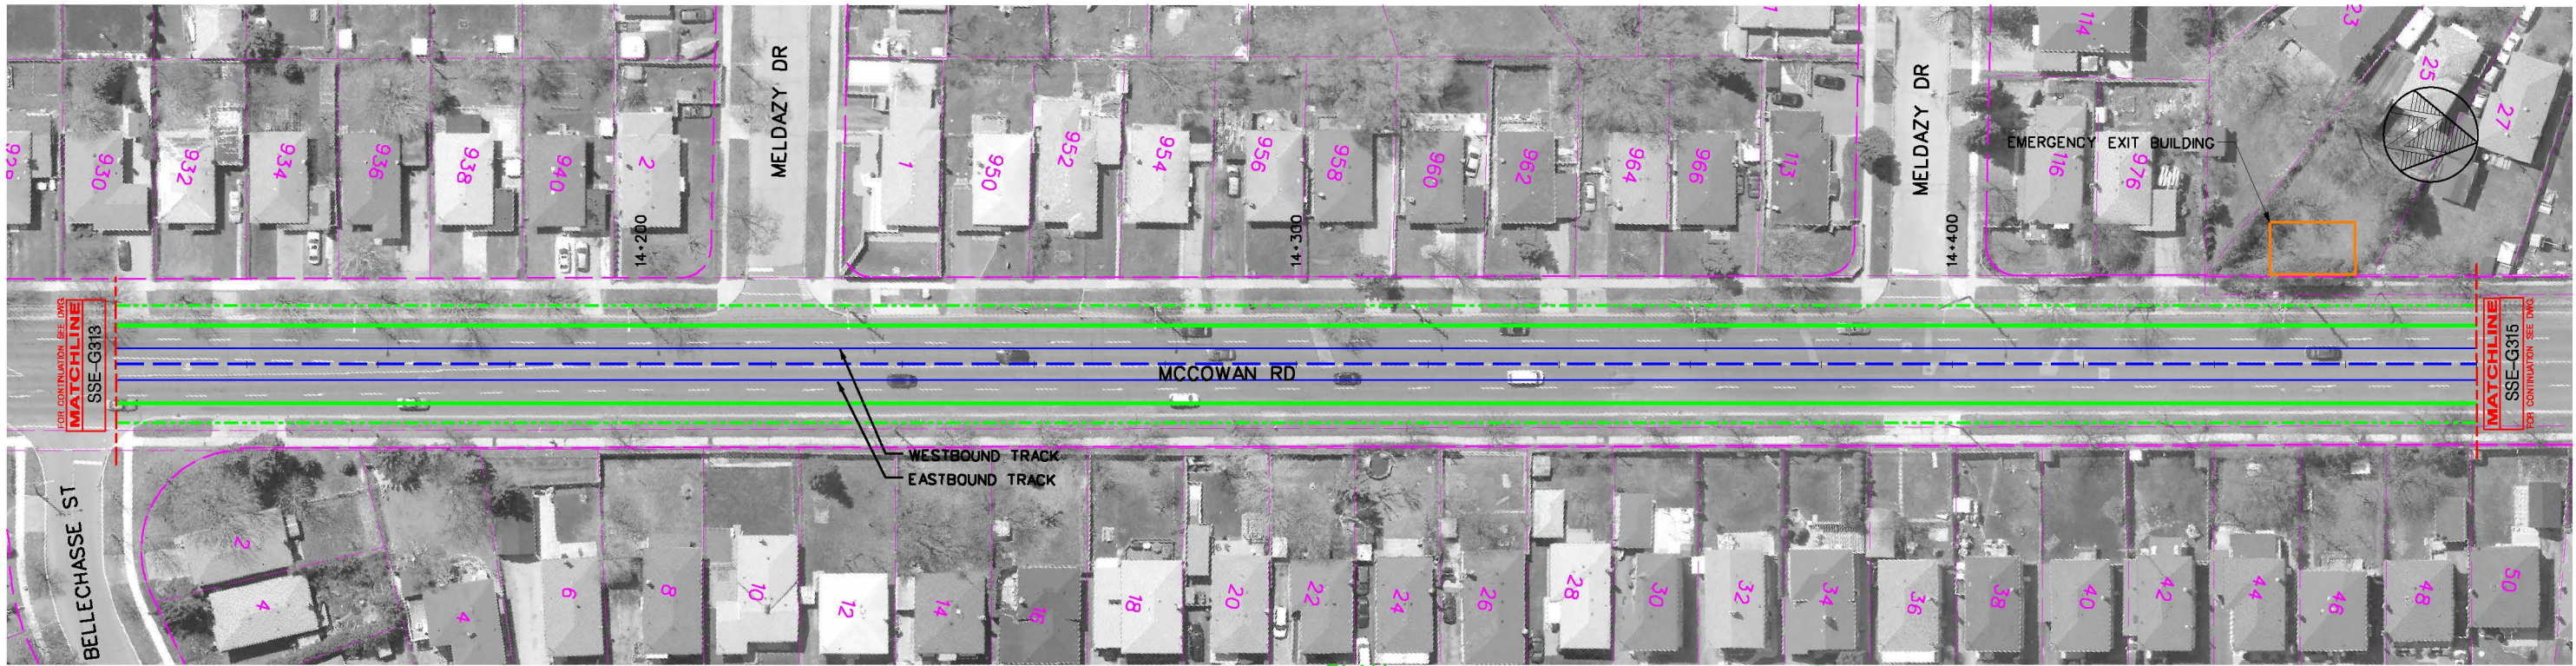

REVISIONS

LEGEND	
	STRUCTURE
	ALIGNMENT ϕ
	NEW TTC RIGHT-OF-WAY
	TRACK ϕ
	EXISTING PROPERTY LINE
	EMERGENCY EXIT BUILDING (EEB)
	TRACTION POWER SUBSTATION




CONCEPTUAL DESIGN
NOT FOR CONSTRUCTION


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CHECKED	D.FANG	2017/02/28
CORRECT	D.FANG	2017/02/28
SCALE		

SCARBOROUGH SUBWAY EXTENSION EA
PLAN AND PROFILE
STA 14+120 TO STA 14+480

Plot Date:	3/10/2017
TORONTO TRANSIT COMMISSION ENGINEERING DEPARTMENT	
Dwg. No.	SSE-G314
Sheet No.	

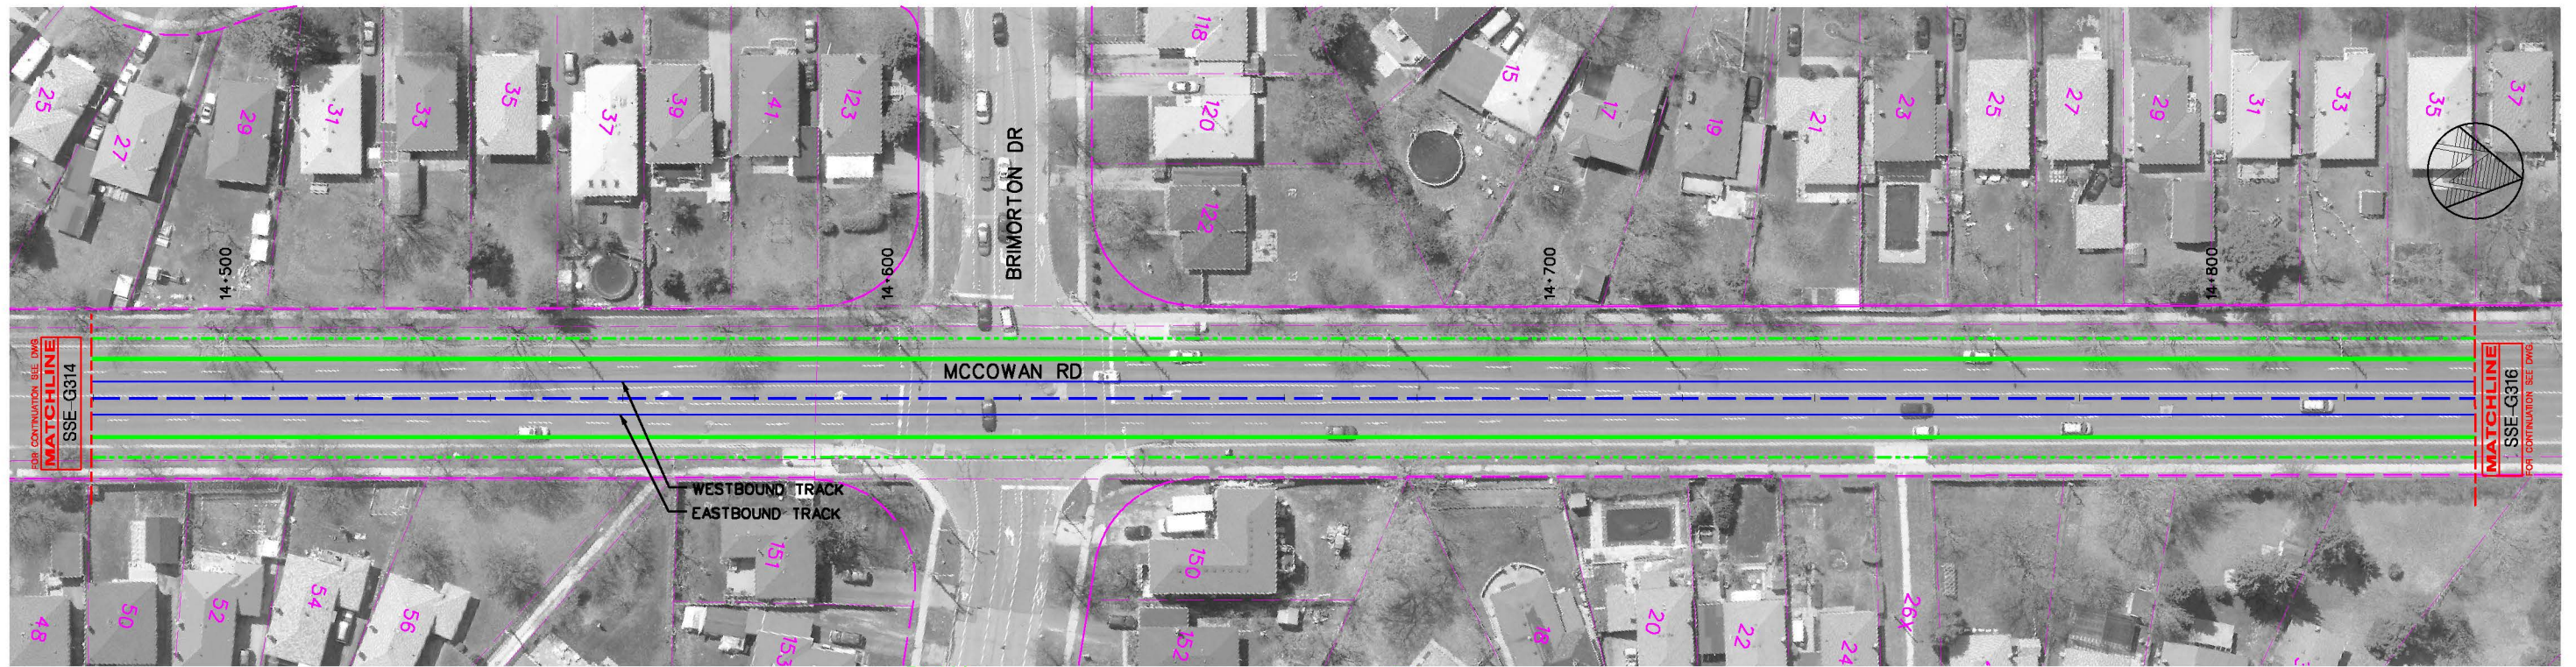

PLAN
STA 14+480 TO STA 14+840
1 G315

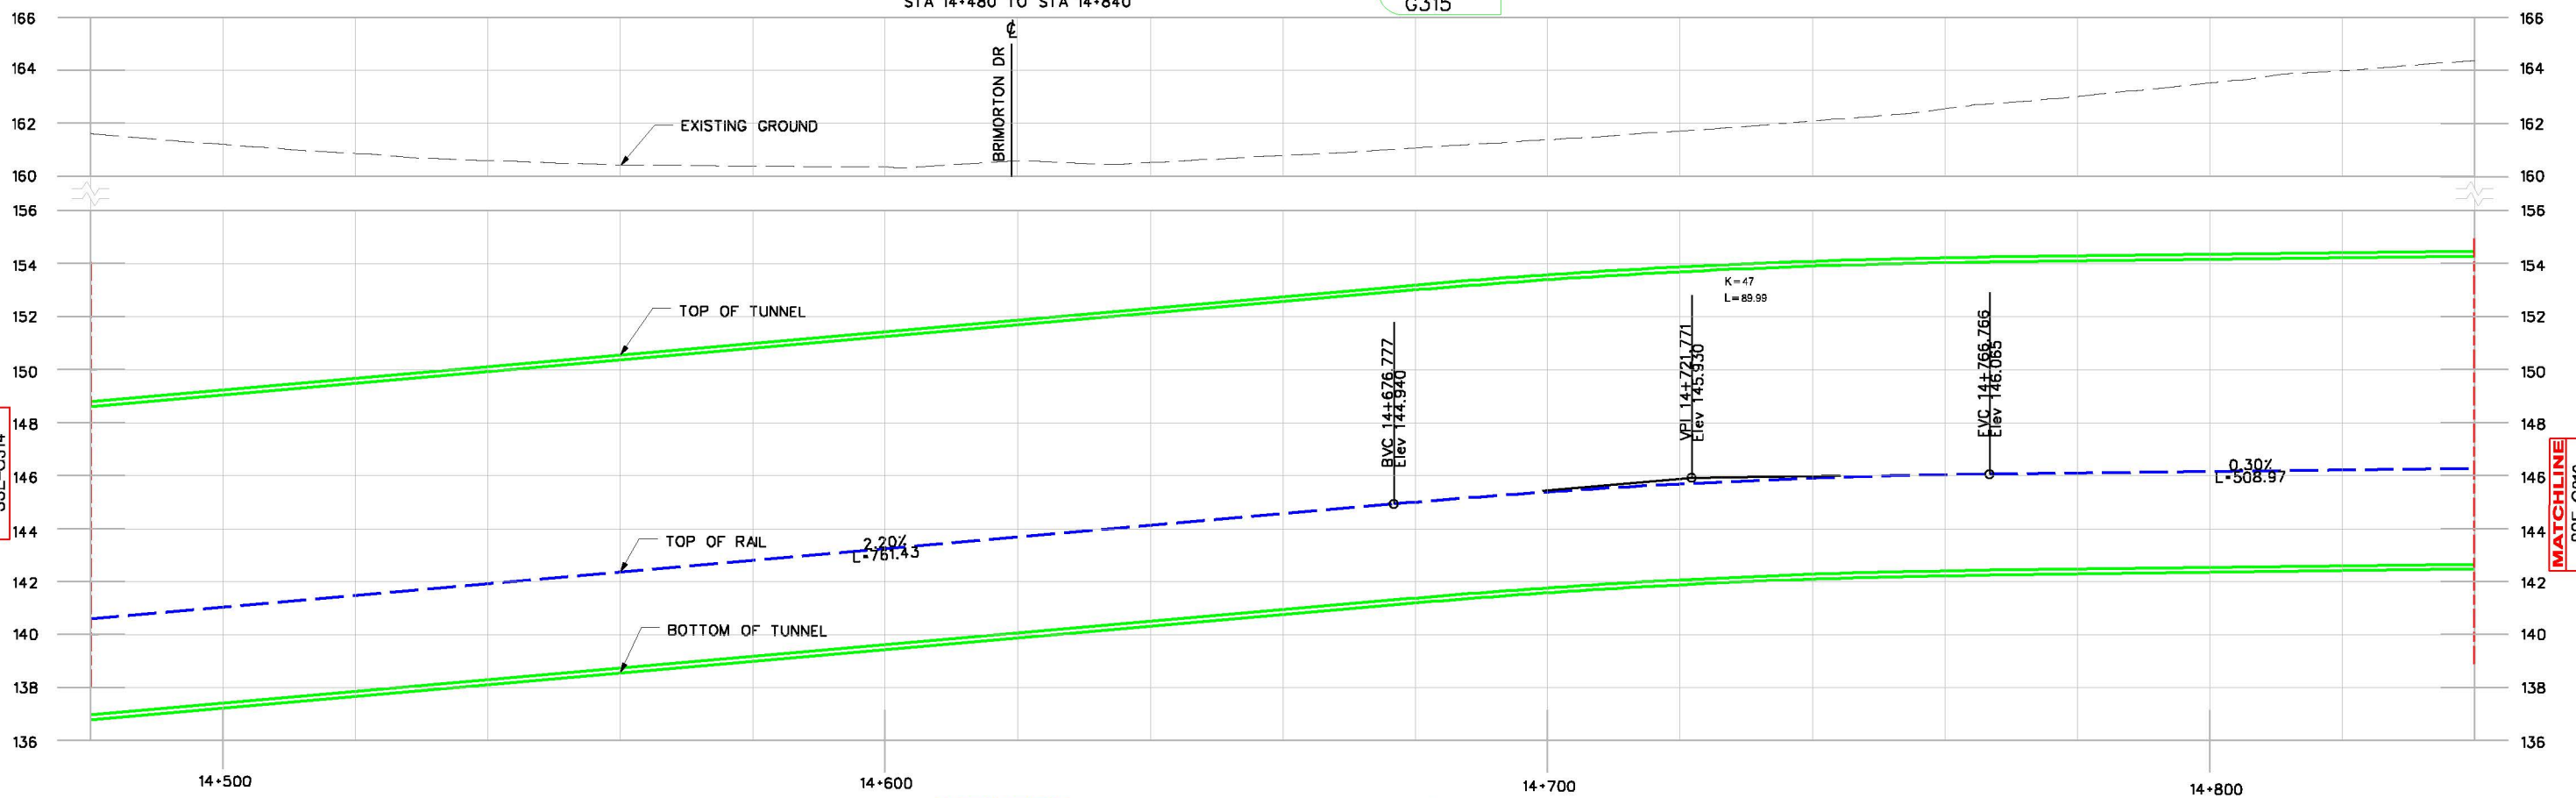

ELEVATION
STA 14+480 TO STA 14+840
1 G315

BUDG. REF. No.

FILENAME:

SHEET No.

DRAWING No.

REVISIONS

LEGEND	
	STRUCTURE
	ALIGNMENT ϕ
	NEW TTC RIGHT-OF-WAY
	TRACK ϕ
	EXISTING PROPERTY LINE
	EMERGENCY EXIT BUILDING (EEB)
	TRACTION POWER SUBSTATION




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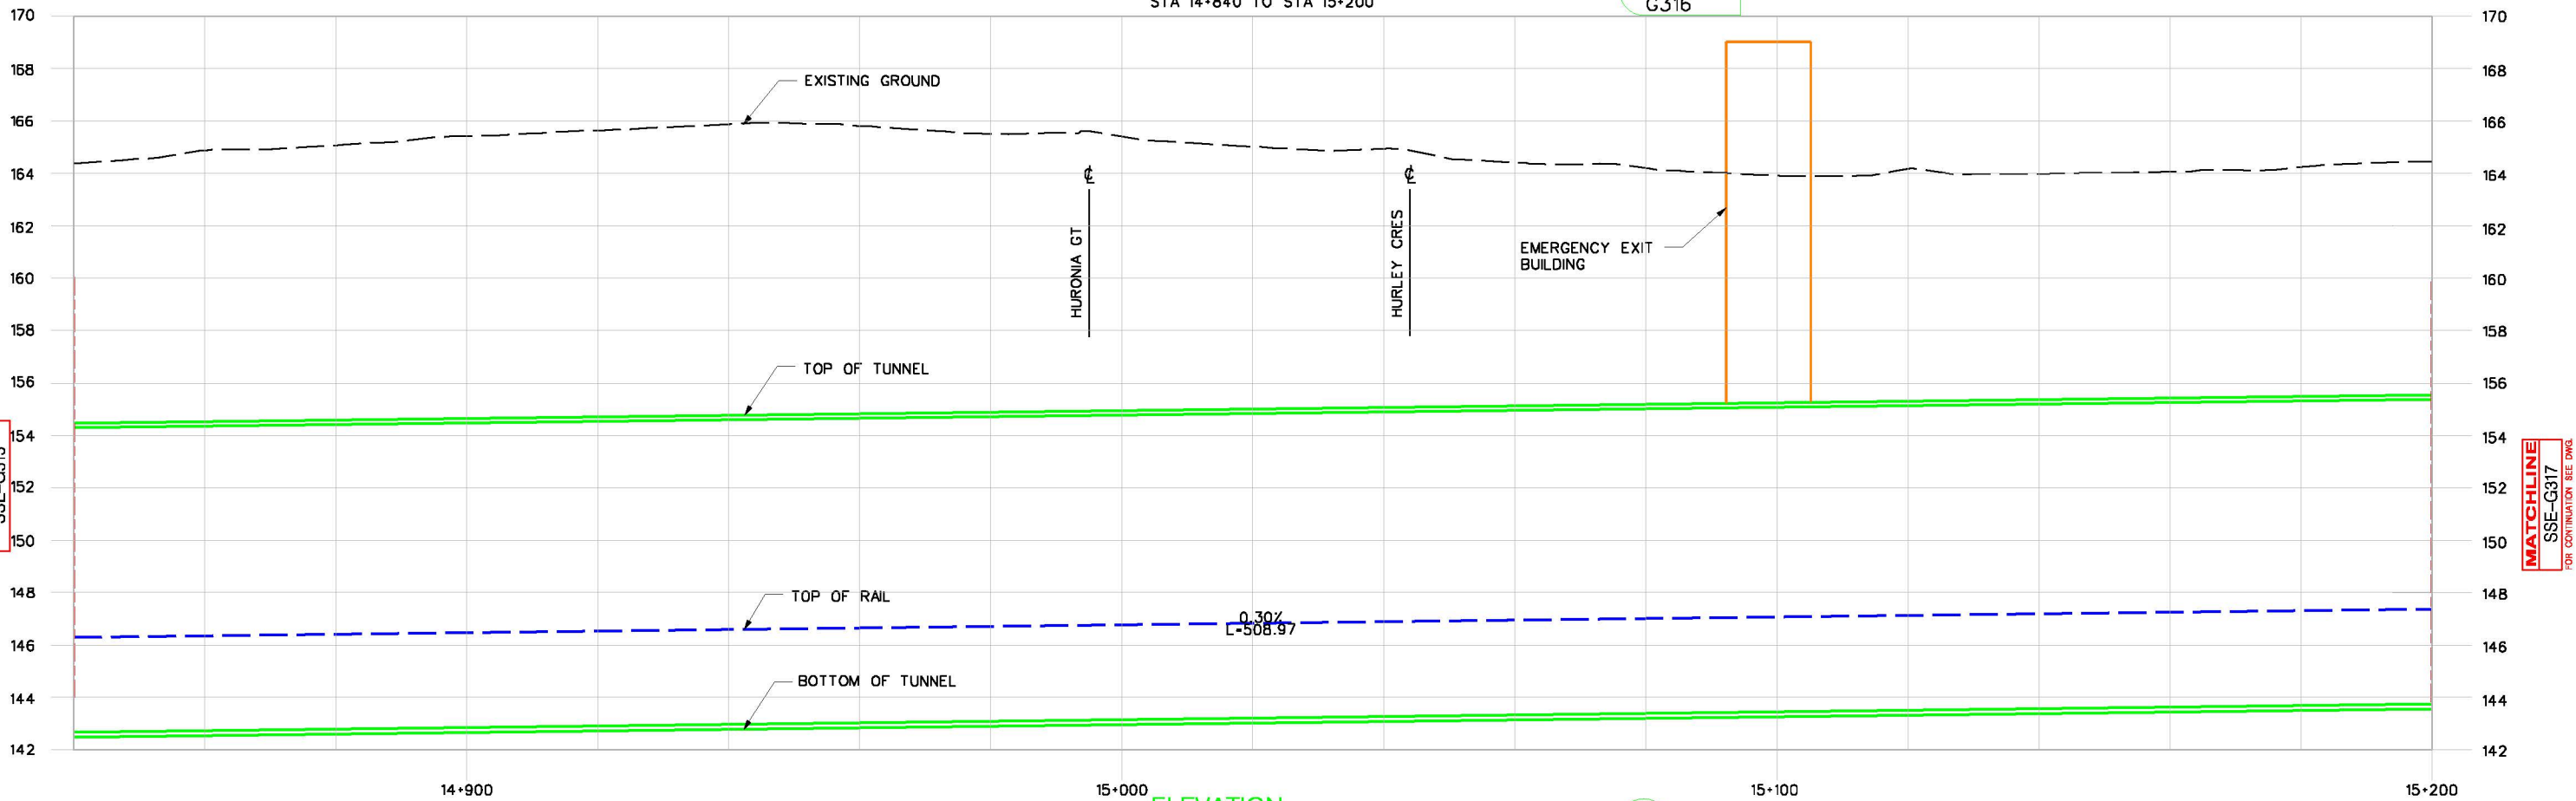
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CHECKED	D.FANG	2017/02/28
CORRECT	D.FANG	2017/02/28
SCALE		

SCARBOROUGH SUBWAY EXTENSION EA
PLAN AND PROFILE
STA 14+480 TO STA 14+840

Plot Date:	3/10/2017
TORONTO TRANSIT COMMISSION ENGINEERING DEPARTMENT	
Dwg. No.	SSE-G315
Sheet No.	

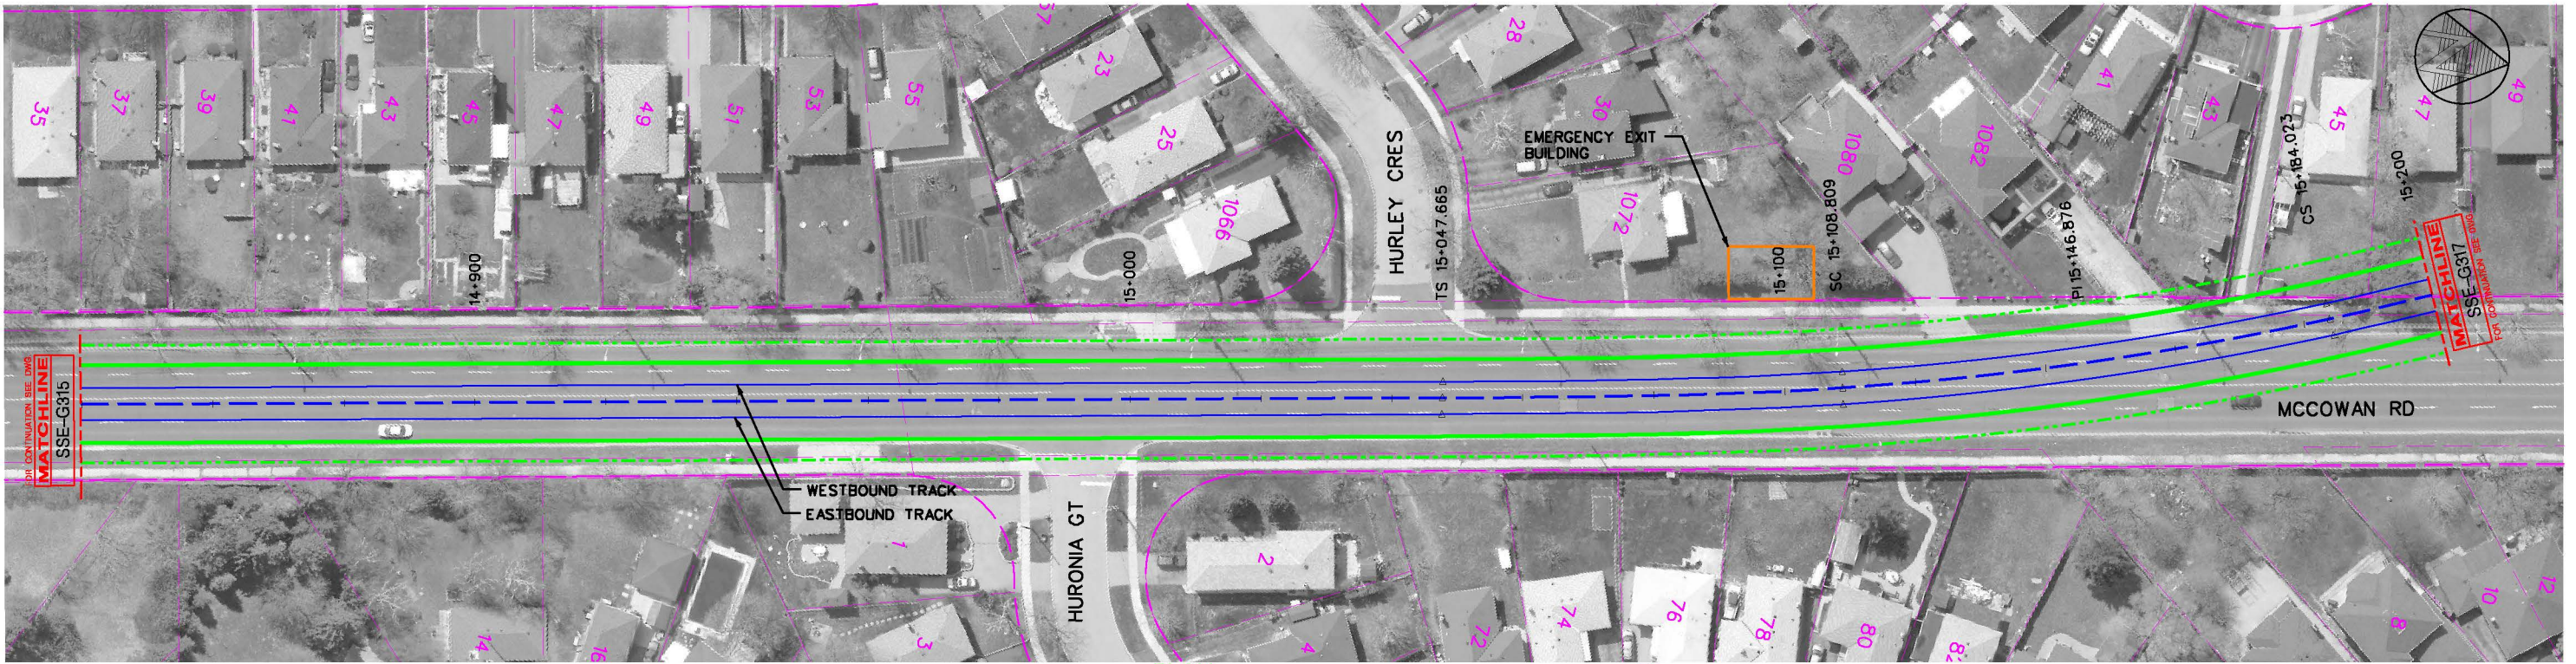

PLAN
STA 14+840 TO STA 15+200



ELEVATION
STA 14+840 TO STA 15+200

NO.	REVISIONS

LEGEND	
	STRUCTURE
	ALIGNMENT ϕ
	NEW TTC RIGHT-OF-WAY
	TRACK ϕ
	EXISTING PROPERTY LINE
	EMERGENCY EXIT BUILDING (EEB)
	TRACTION POWER SUBSTATION




CONCEPTUAL DESIGN
NOT FOR CONSTRUCTION


DRAWN	L. LI	2017/02/28
CHECKED	D. FANG	2017/02/28
CORRECT	D. FANG	2017/02/28
SCALE		

SCARBOROUGH SUBWAY EXTENSION EA
PLAN AND PROFILE
STA 14+840 TO STA 15+200

Plot Date:	3/10/2017
TORONTO TRANSIT COMMISSION ENGINEERING DEPARTMENT	
Dwg. No.	SSE-G316
Sheet No.	

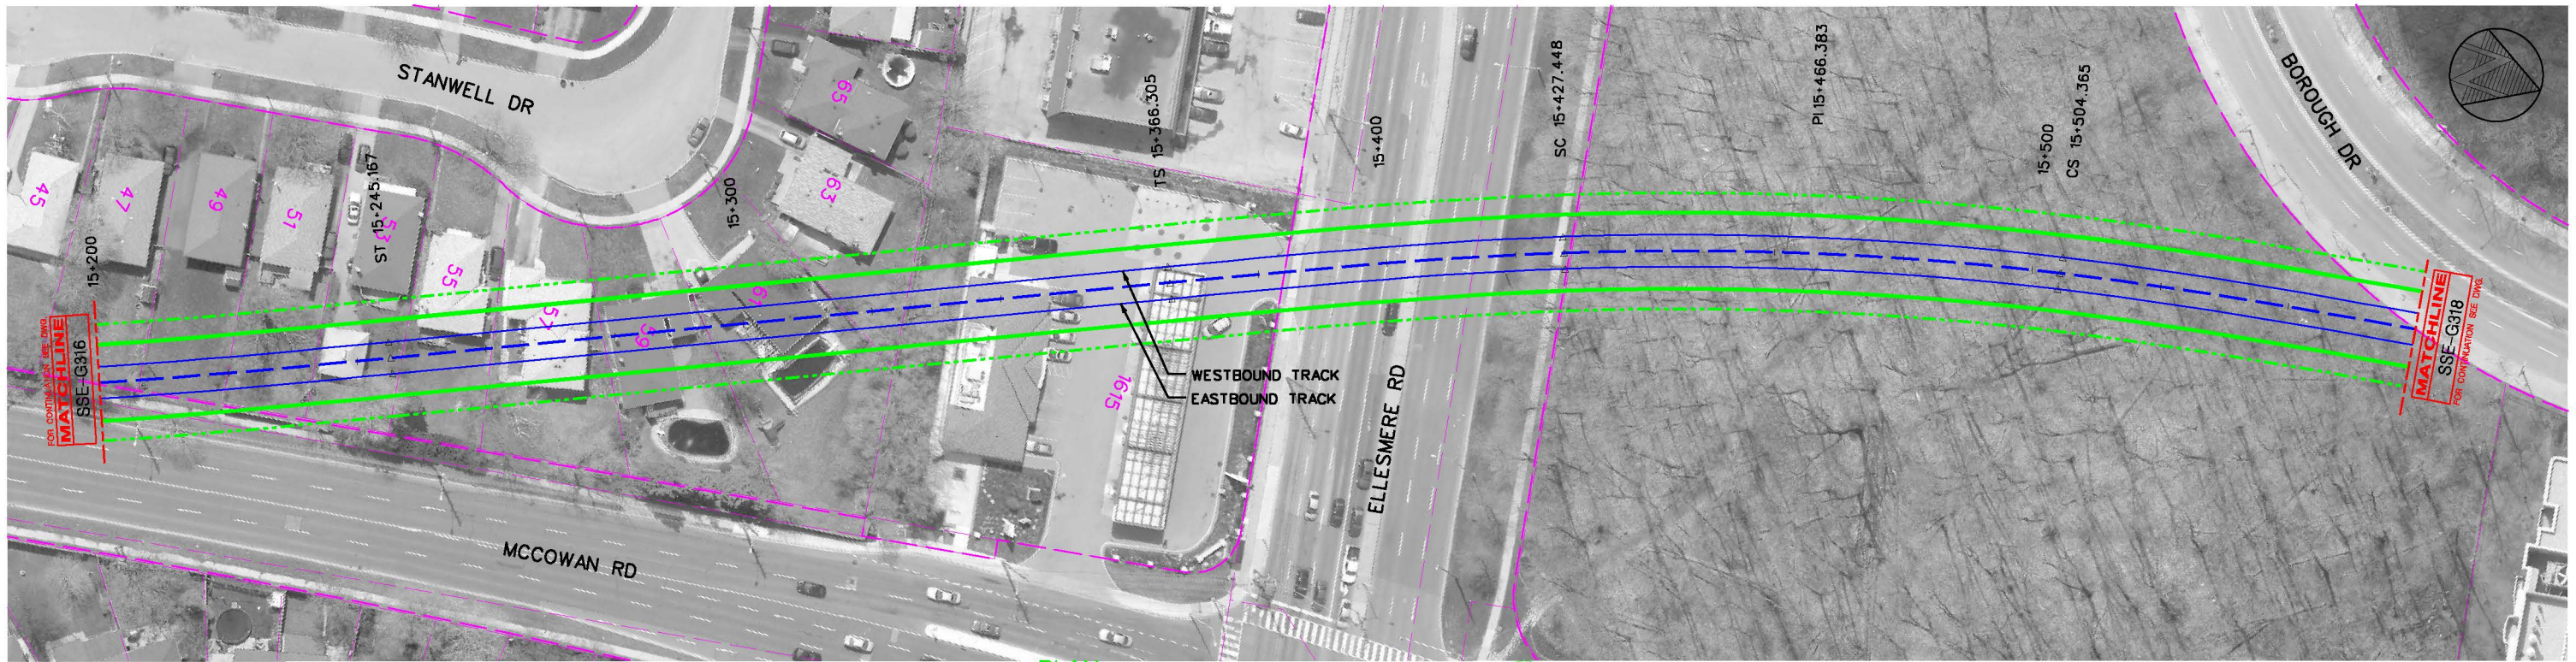

PLAN
STA 15+200 TO STA 15+560
1 G317

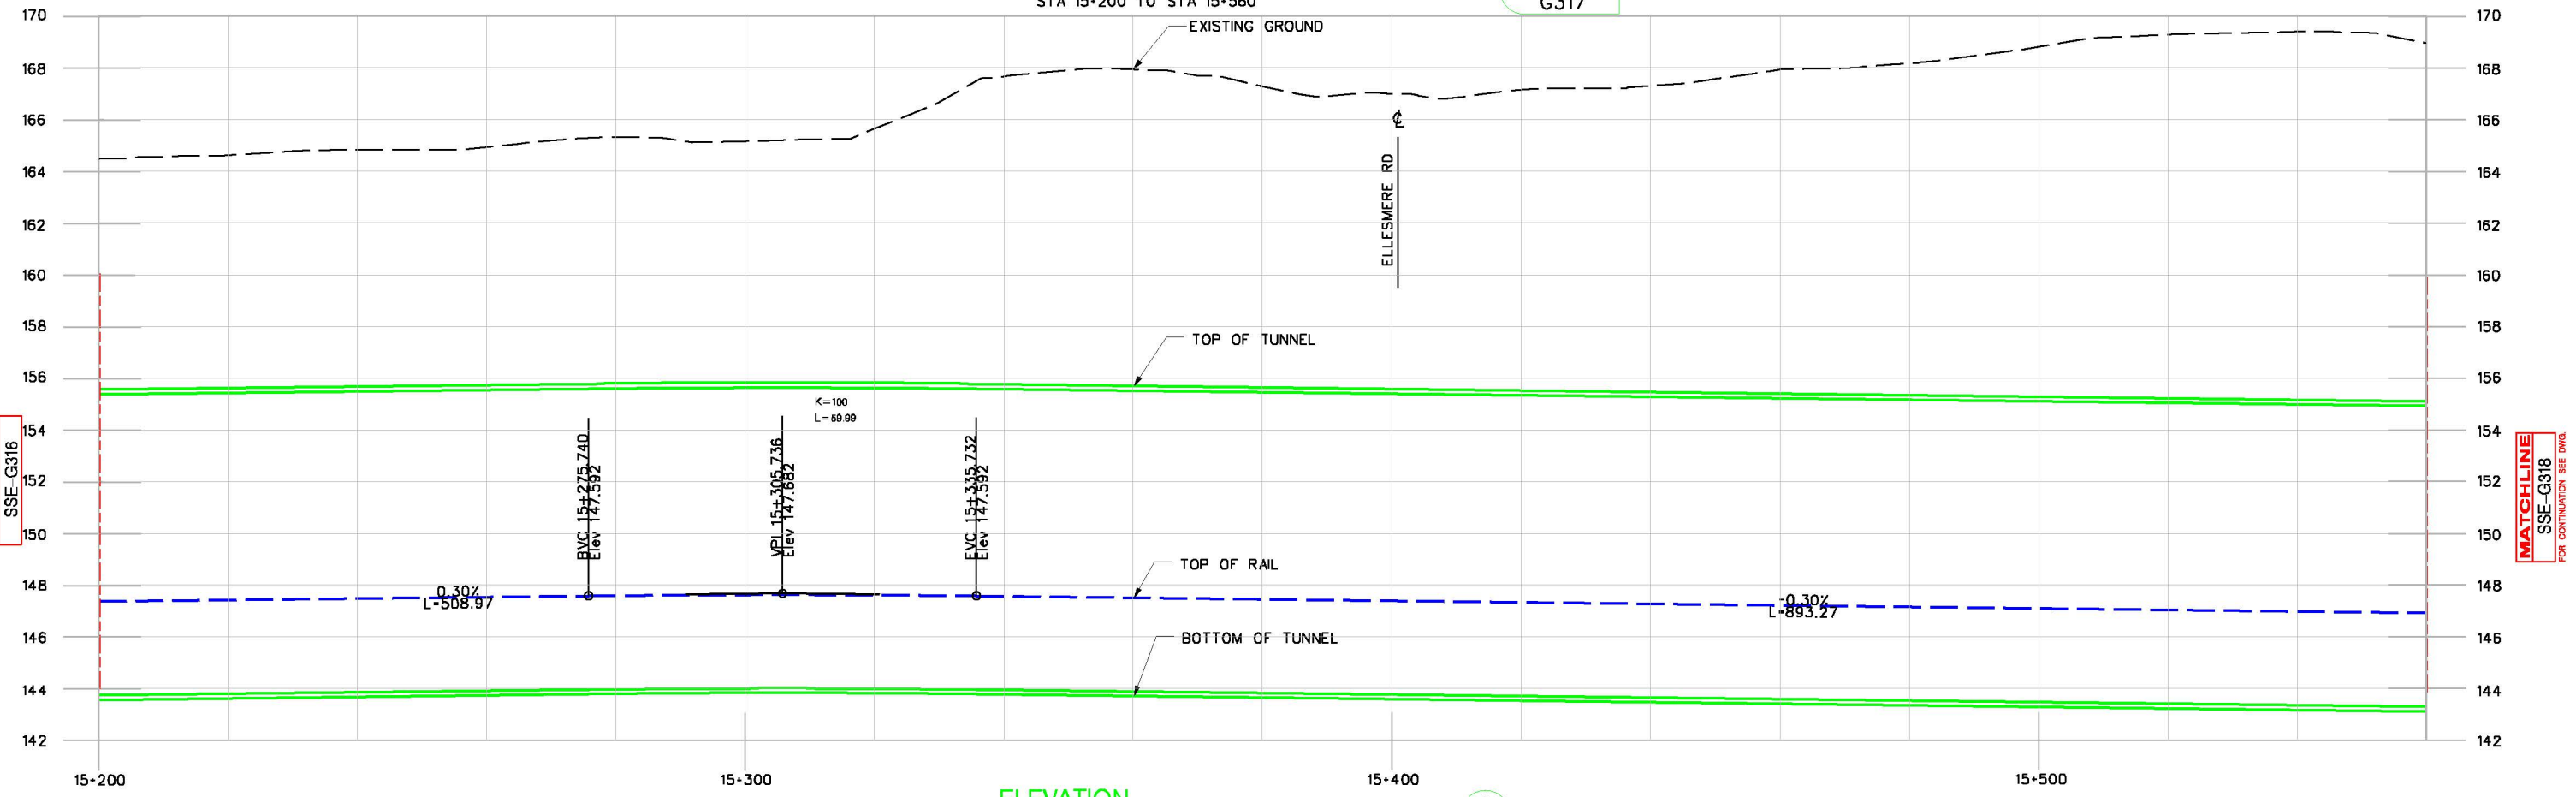

ELEVATION
STA 15+200 TO STA 15+560
1 G317

REVISIONS

LEGEND	
	STRUCTURE
	ALIGNMENT
	NEW TTC RIGHT-OF-WAY
	TRACK
	EXISTING PROPERTY LINE
	EMERGENCY EXIT BUILDING (EEB)
	TRACTION POWER SUBSTATION



CONCEPTUAL DESIGN
NOT FOR CONSTRUCTION


DRAWN	L. LI	2017/02/28
CHECKED	D. FANG	2017/02/28
CORRECT	D. FANG	2017/02/28

SCALE
HOR: 1" = 100'
VER: 1" = 25.0'

SCARBOROUGH SUBWAY EXTENSION EA
PLAN AND PROFILE
STA 15+200 TO STA 15+560


Plot Date:	3/10/2017
TORONTO TRANSIT COMMISSION ENGINEERING DEPARTMENT	
Dwg. No.	SSE-G317
Sheet No.	

engpawd.dgn (SCHEM) JULY 2, 2015

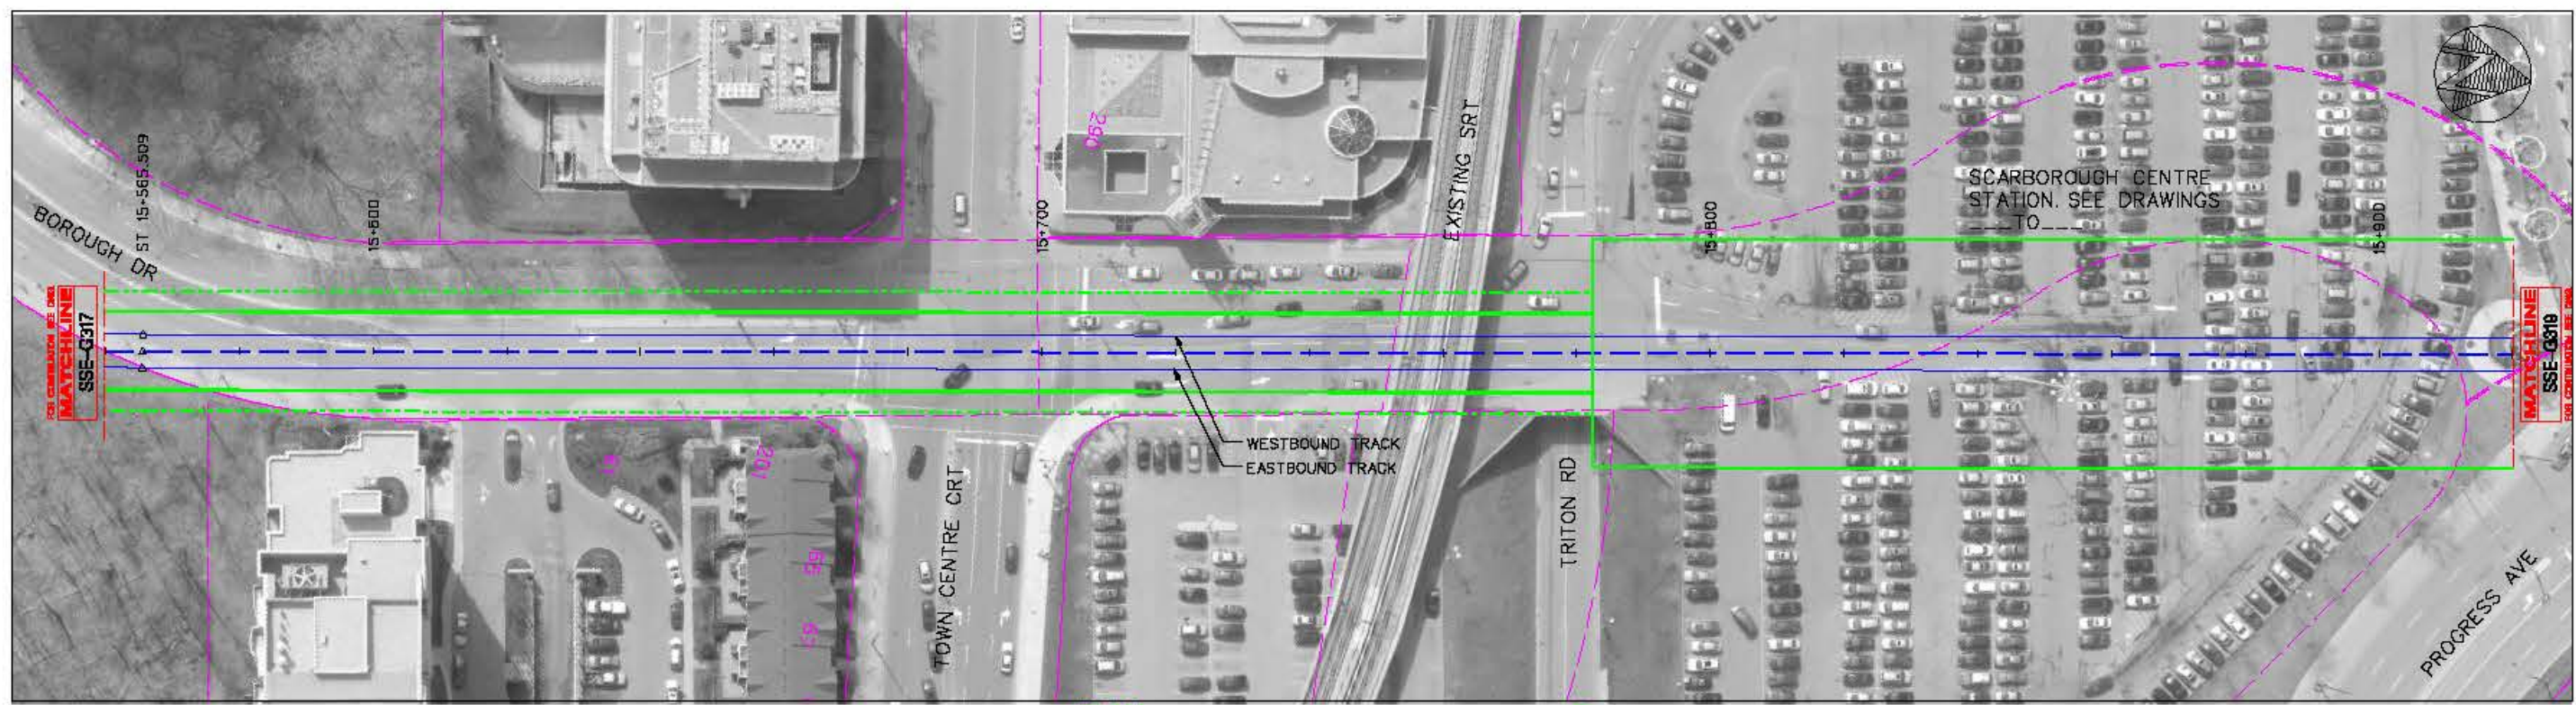

PLAN
STA 15+560 TO STA 15+920

NOTE: TRACTION POWER SUBSTATION FACILITY IS LOCATED WITHIN STATION BUILDING.

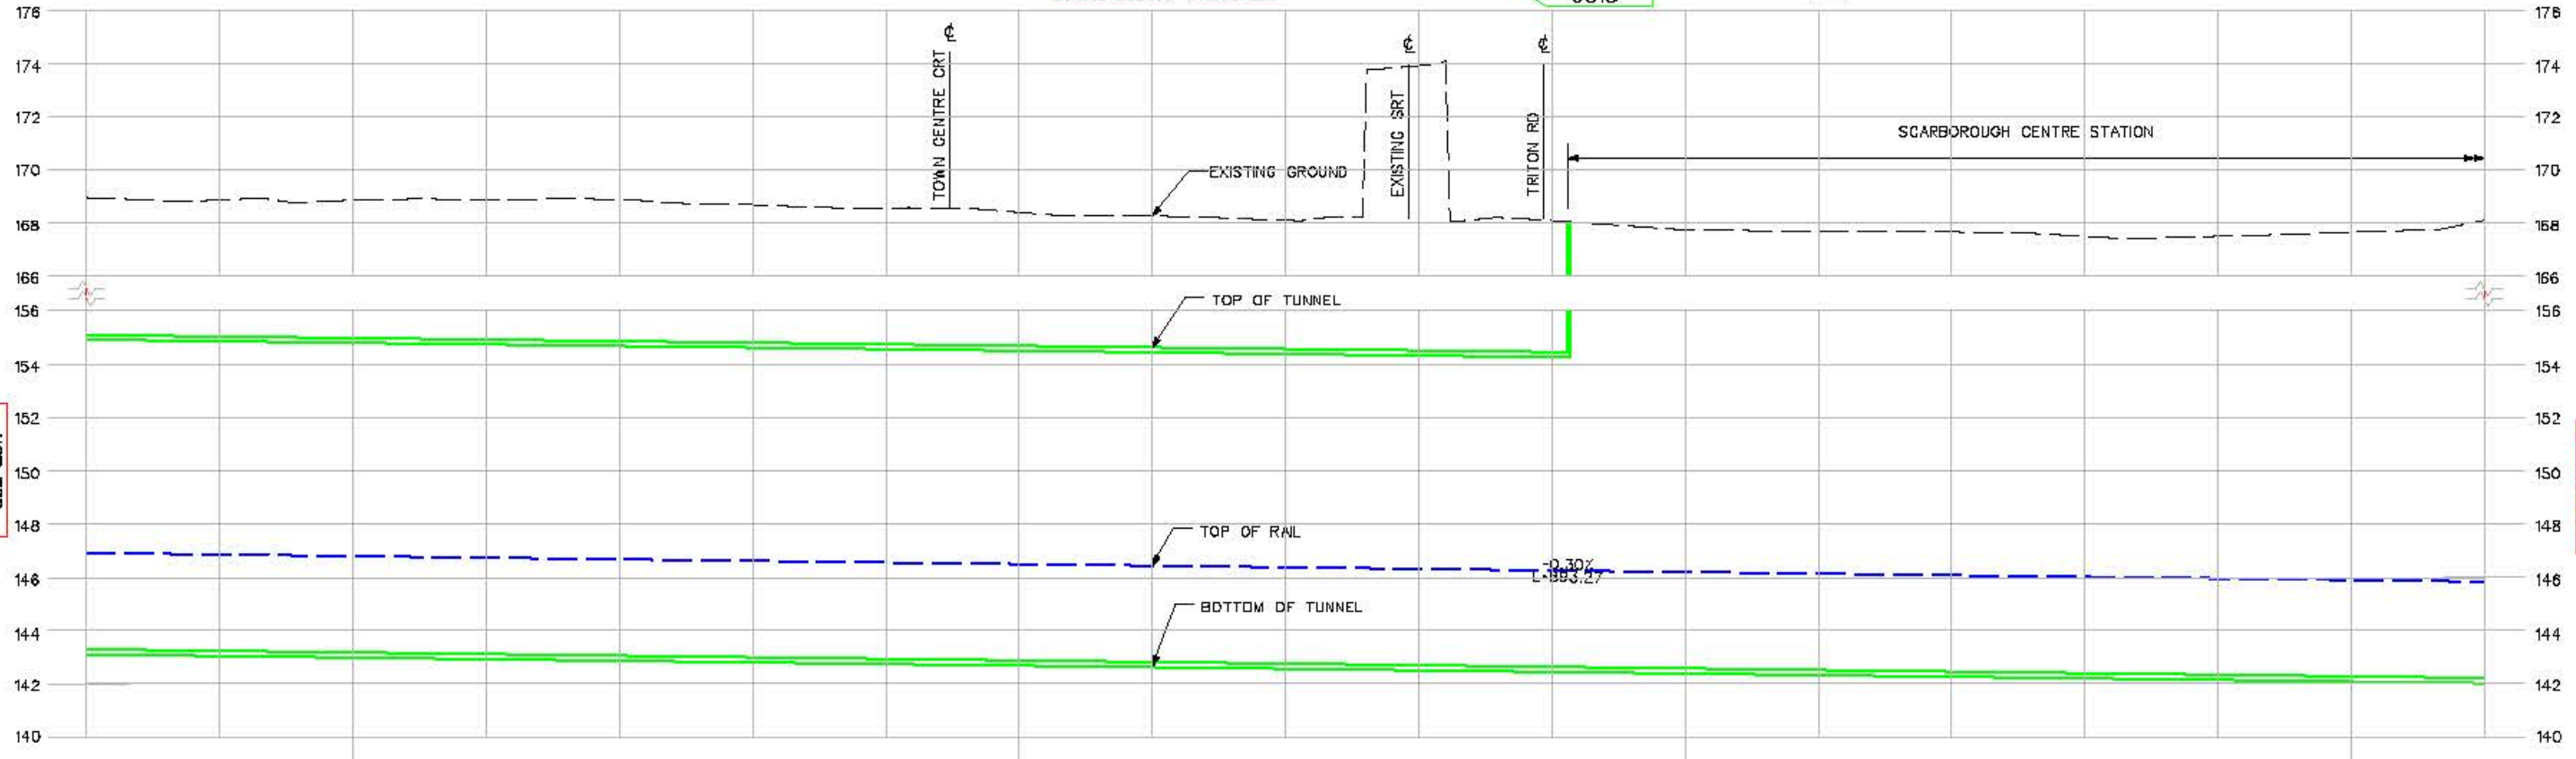

ELEVATION
STA 15+560 TO STA 15+920

BLDG. REF. No.

FILENAME

SHEET No.

FOR CONTINUATION SEE DWG.
MATCHLINE
SSE-G317

MATCHLINE
SSE-G319
FOR CONTINUATION SEE DWG.

REVISIONS

LEGEND	
	STRUCTURE
	ALIGNMENT
	NEW TTC RIGHT-OF-WAY
	TRACK
	EXISTING PROPERTY LINE
	EMERGENCY EXIT BUILDING (EEB)
	TRACTION POWER SUBSTATION



CONCEPTUAL DESIGN
NOT FOR CONSTRUCTION

DATE	2017/02/28
DESIGNED BY	J. D. E. AND
CHECKED BY	J. D. E. AND
SCALE	1" = 100'
HOR	1" = 100'
VER	1" = 12.50'

SCARBOROUGH SUBWAY EXTENSION EA
PLAN AND PROFILE
STA 15+560 TO STA 15+920


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TORONTO TRANSIT COMMISSION ENGINEERING DEPARTMENT	
Draw. No.	SSE-G318
Sheet No.	

ENGINEER: J. BORDEN, JULY 2, 2015



PLAN
STA 15+920 TO STA 16+230

NOTE: TRACTION POWER SUBSTATION FACILITY IS LOCATED WITHIN STATION BUILDING.

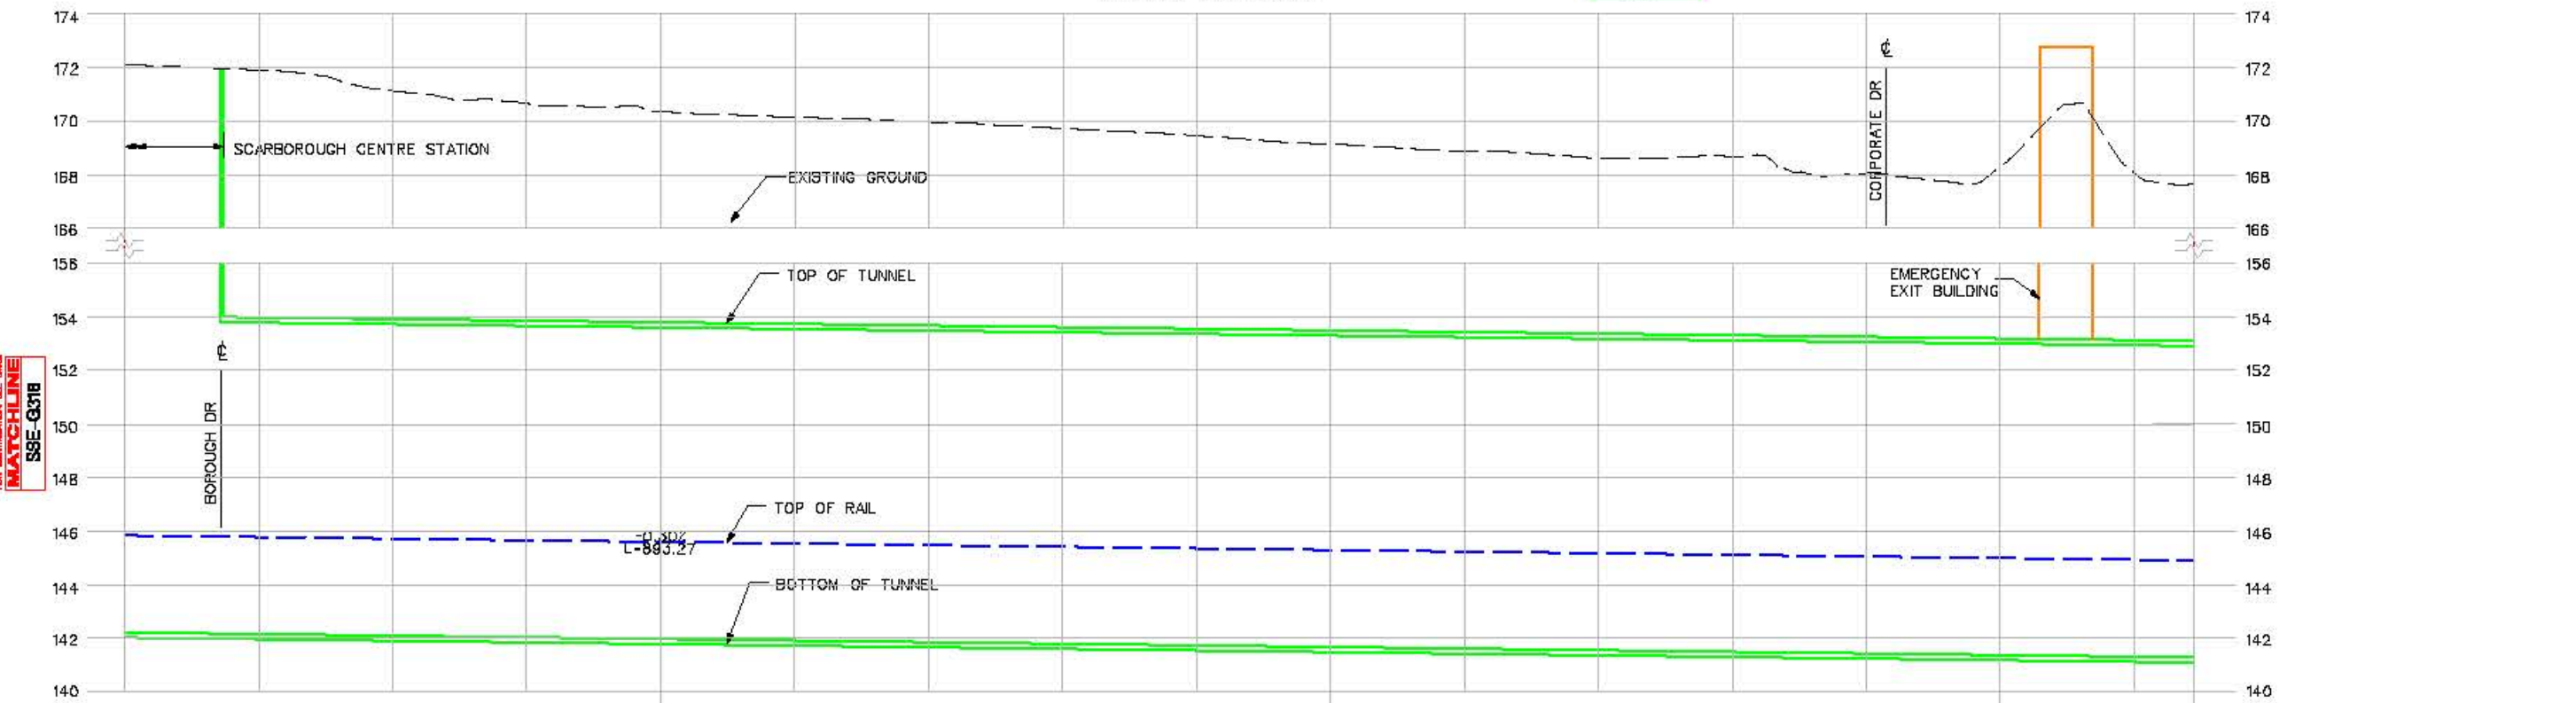

ELEVATION
STA 15+920 TO STA 16+230

BLDG. REF. No.

FILENAME:

SHEET No.

DRAWING No.

FOR CONTINUATION SEE OVERLAP
MATCHLINE
SSE-G318

1
G319

1
G319

NO.	REVISIONS

LEGEND	
	STRUCTURE
	ALIGNMENT
	NEW TTC RIGHT-OF-WAY
	TRACK
	EXISTING PROPERTY LINE
	EMERGENCY EXIT BUILDING (EEB)
	TRACTION POWER SUBSTATION



CONCEPTUAL DESIGN
NOT FOR CONSTRUCTION

DRAWN: C. LIL	YYYY/MM/DD	2017/02/28
CHECKED: D. ENGB	2017/02/28	
CONVERT: D. ENGB	2017/02/28	
SCALE: 1" = 100'		
HOR: 1" = 100'		
VER: 1" = 25'		

SCARBOROUGH SUBWAY EXTENSION EA

PLAN AND PROFILE

STA 15+920 TO STA 16+229.081

File Date: 7/20/2017
TORONTO TRANSIT COMMISSION ENGINEERING DEPARTMENT
Draw. No. SSE-G319
Sheet No.