


PLAN
STA. 10+000 TO STA. 12+920

1
G300

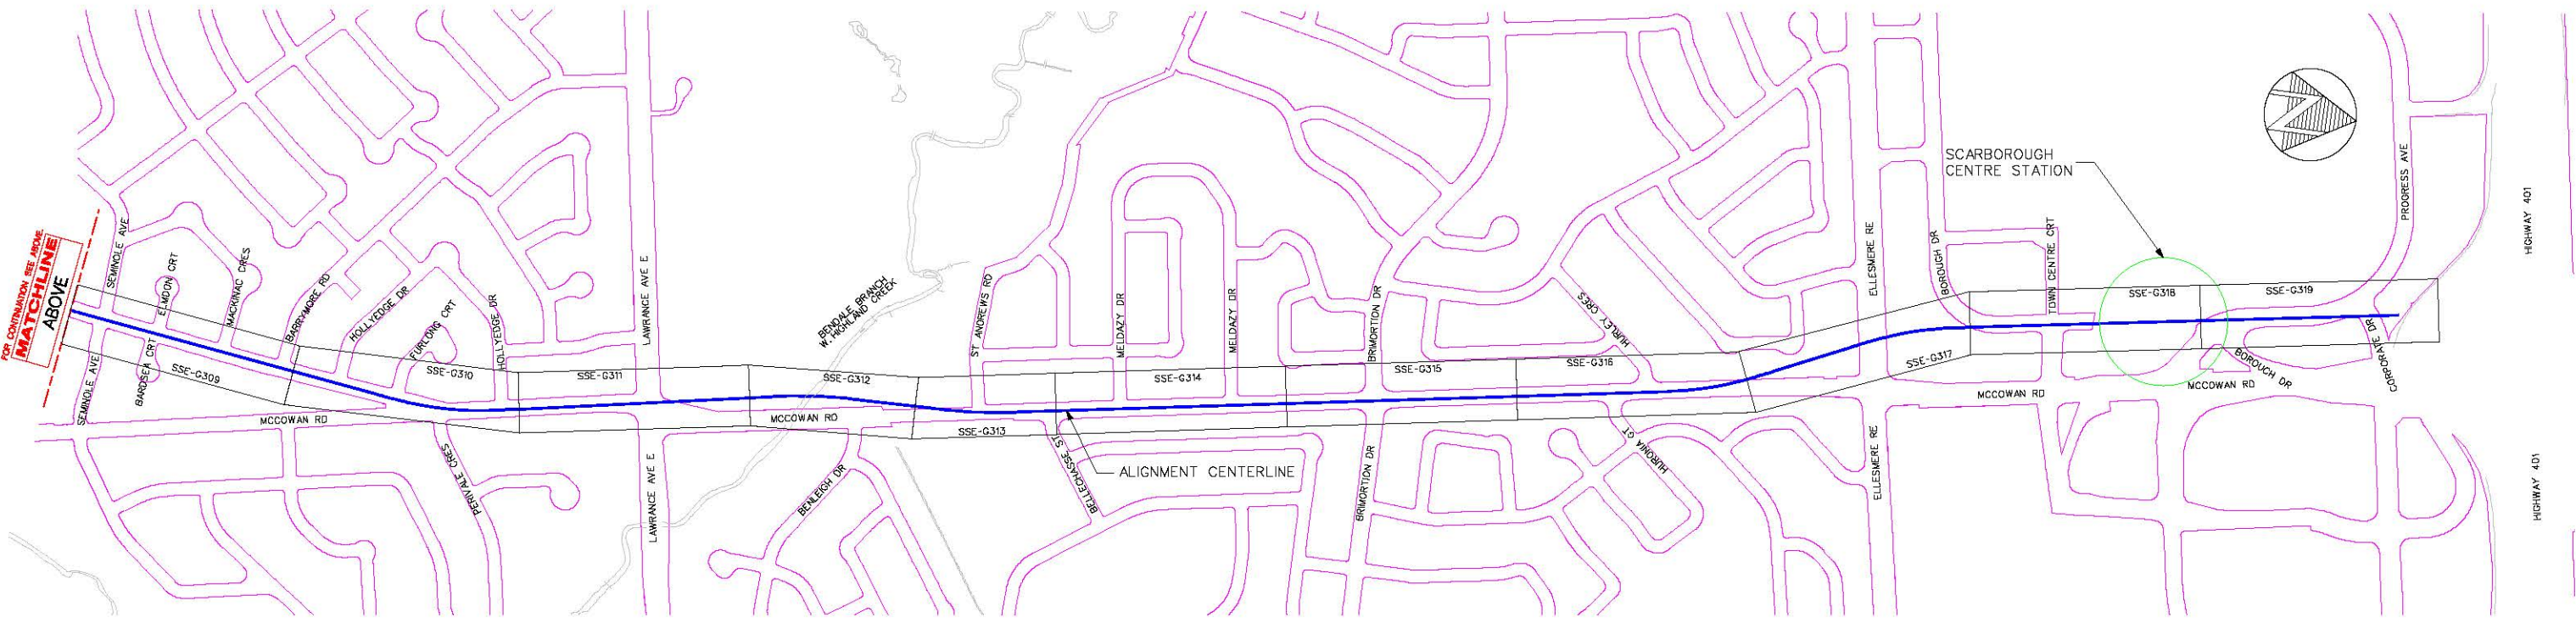

PLAN
STA. 12+920 TO STA. 16+229.081

2
G300

REVISIONS



CONCEPTUAL DESIGN
NOT FOR CONSTRUCTION


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SCARBOROUGH SUBWAY EXTENSION EA
PLAN AND PROFILE
KEYPLAN

Plot Date:	7/29/2017
TORONTO TRANSIT COMMISSION ENGINEERING DEPARTMENT	
Dwg. No.	SSE-G300
Sheet No.	



PLAN
STA 10+000 TO STA 10+340
1 G301

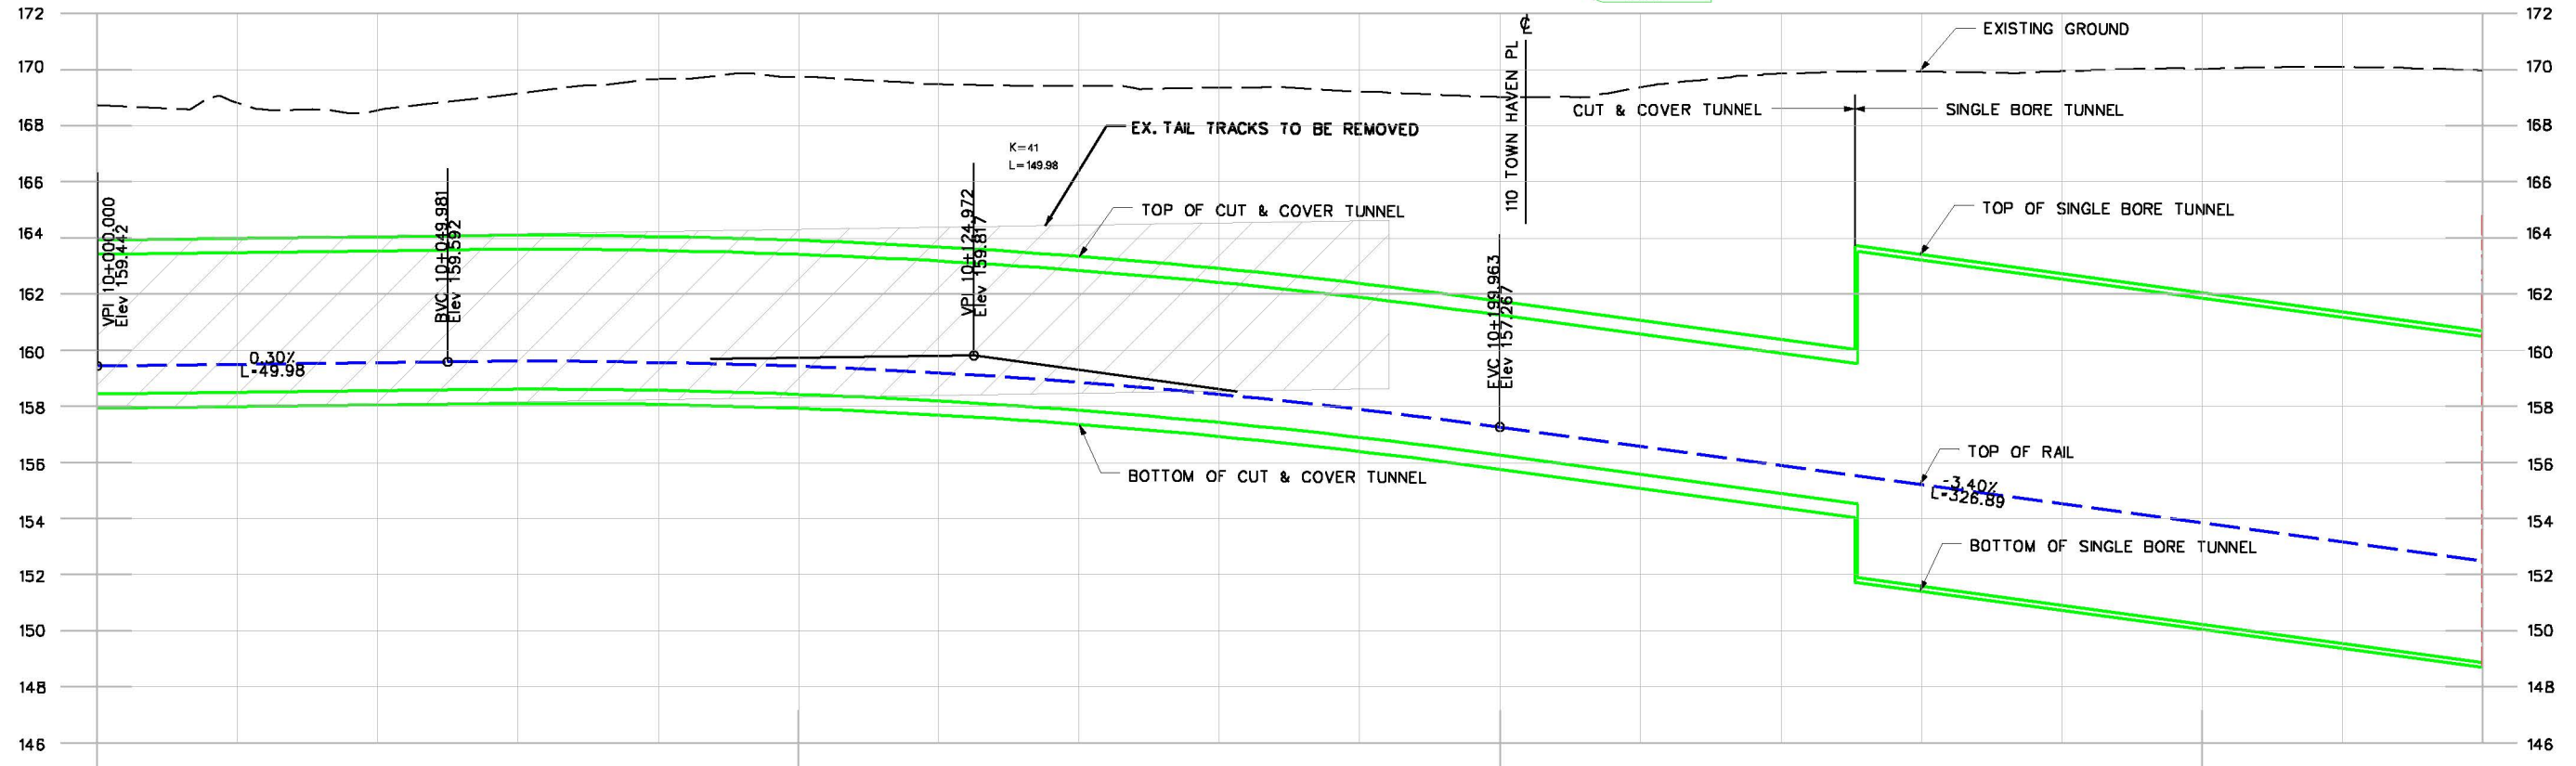

ELEVATION
STA 10+000 TO STA 10+340
1 G301

REVISIONS

LEGEND	
	STRUCTURE
	ALIGNMENT ϕ
	NEW TTC RIGHT-OF-WAY
	TRACK ϕ
	EXISTING PROPERTY LINE
	EMERGENCY EXIT BUILDING (EEB)
	TRACTION POWER SUBSTATION




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NOT FOR CONSTRUCTION


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SCARBOROUGH SUBWAY EXTENSION EA
PLAN AND PROFILE
STA 10+000 TO STA 10+340

Plot Date:	3/9/2017
TORONTO TRANSIT COMMISSION ENGINEERING DEPARTMENT	
Dwg. No.	SSE-G301
Sheet No.	

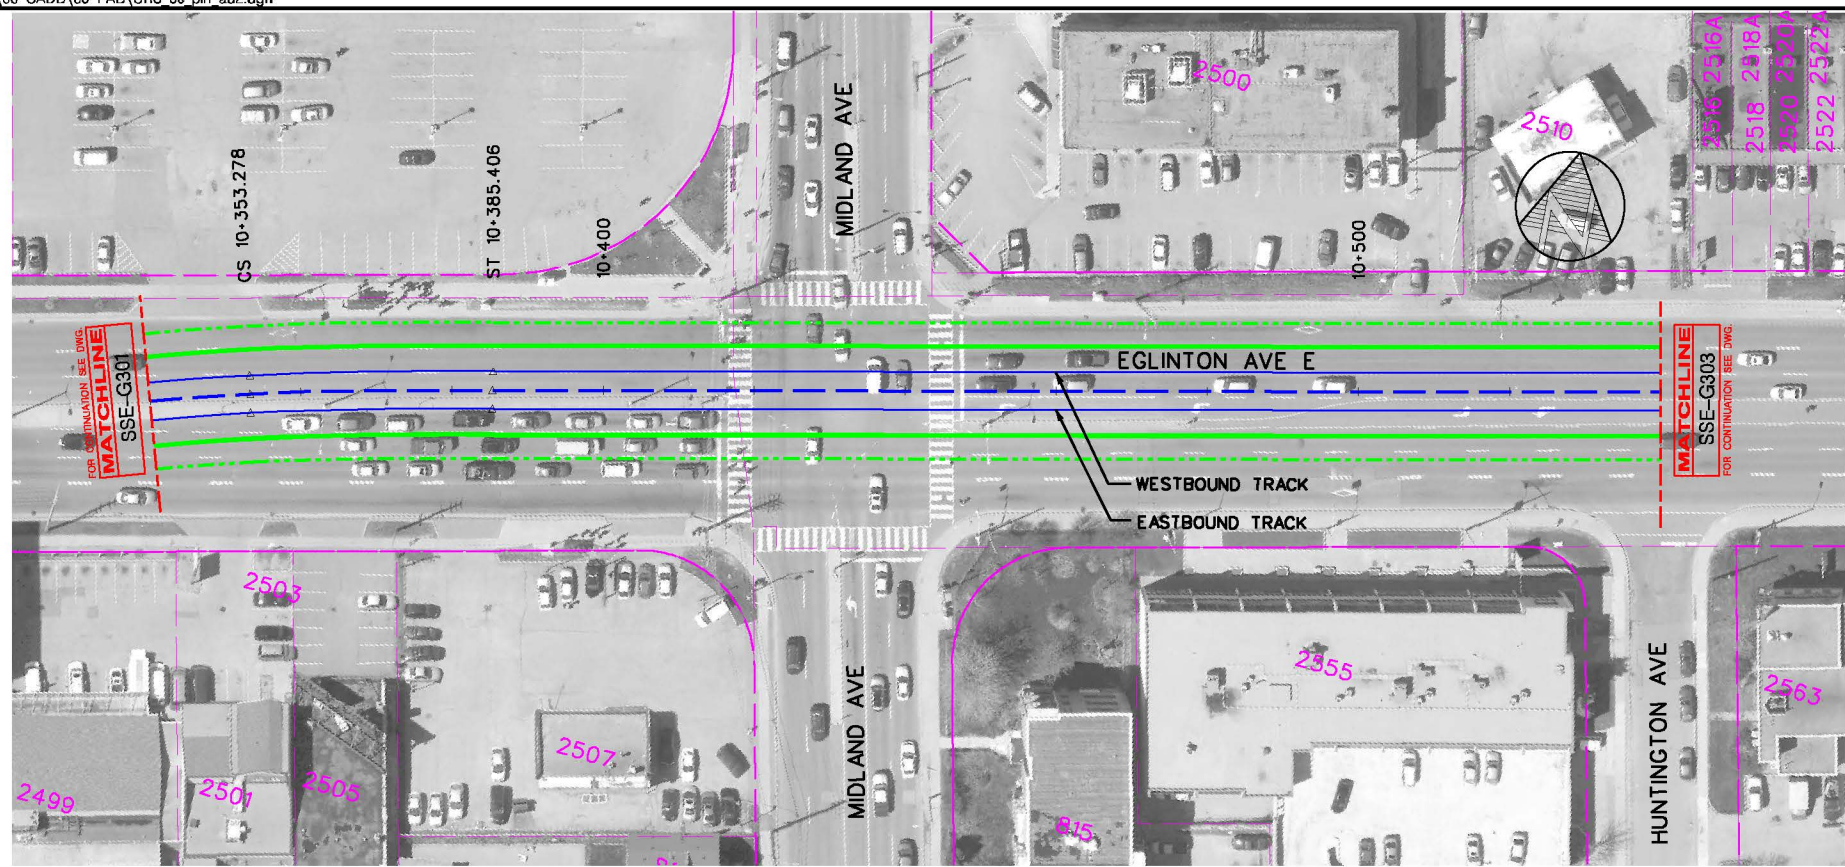

PLAN
STA 10+340 TO STA 10+540
1 G302

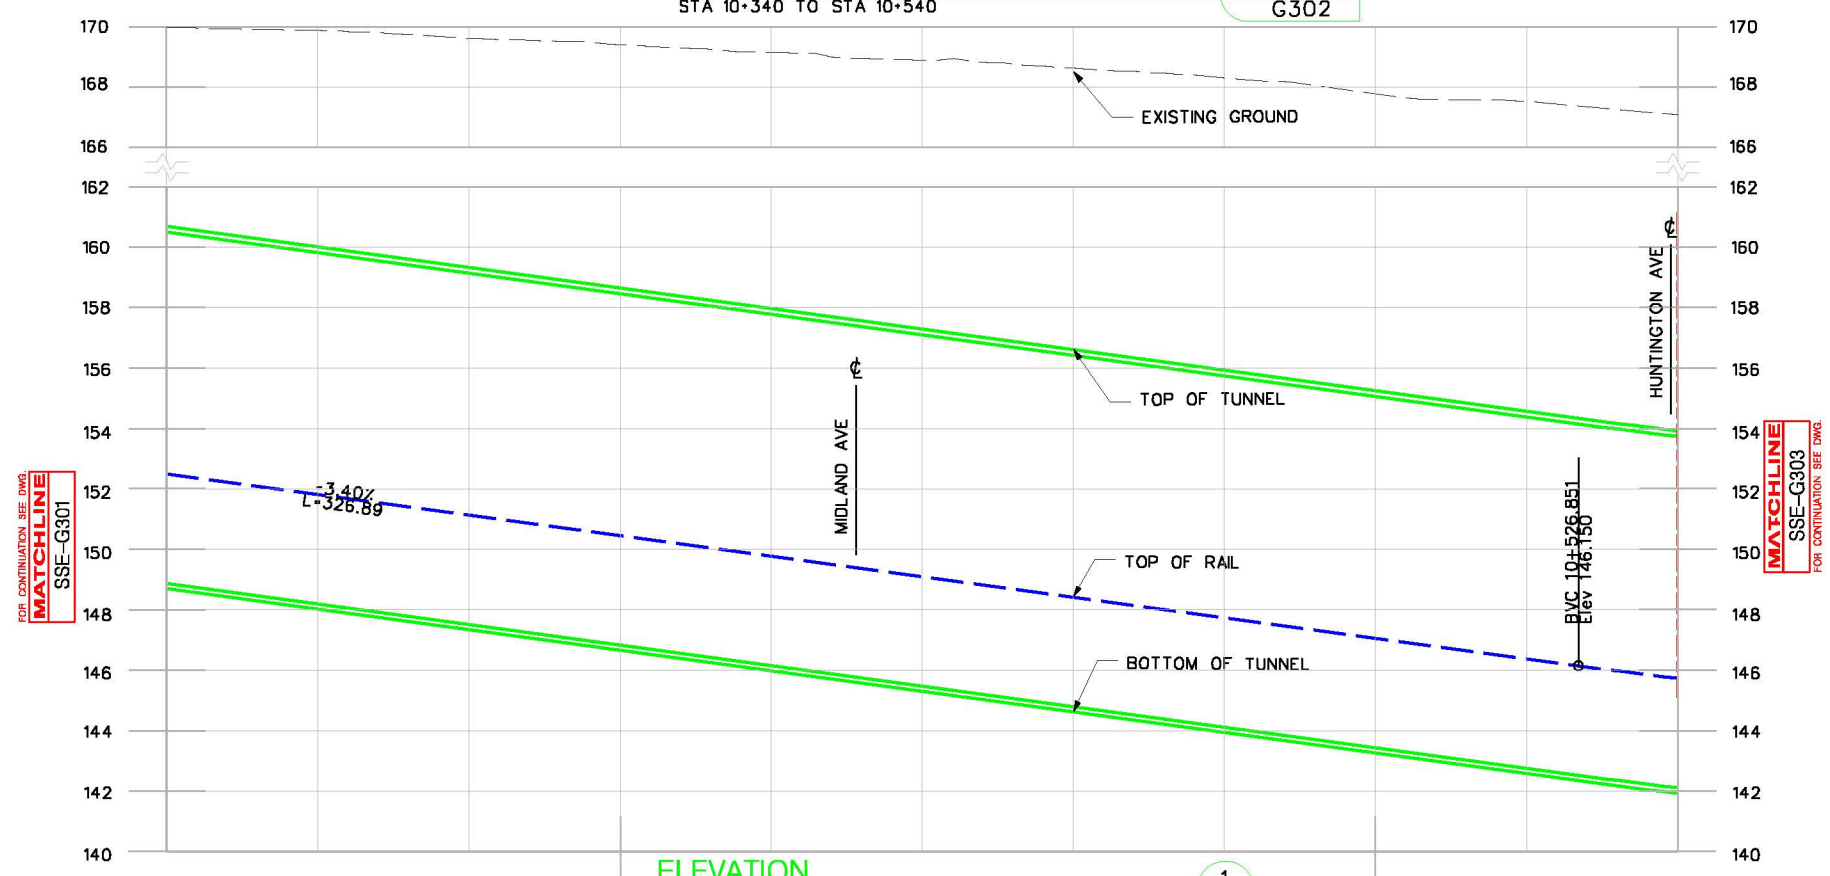

ELEVATION
10+400 STA 10+340 TO STA 10+540
1 G302 10+500

REVISIONS

LEGEND	
	STRUCTURE
	ALIGNMENT
	NEW TTC RIGHT-OF-WAY
	TRACK
	EXISTING PROPERTY LINE
	EMERGENCY EXIT BUILDING (EEB)
	TRACTION POWER SUBSTATION




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NOT FOR CONSTRUCTION


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SCARBOROUGH SUBWAY EXTENSION EA
PLAN AND PROFILE
STA 10+340 TO STA 10+540

Plot Date:	3/9/2017
TORONTO TRANSIT COMMISSION ENGINEERING DEPARTMENT	
Dwg. No.	SSE-G302
Sheet No.	

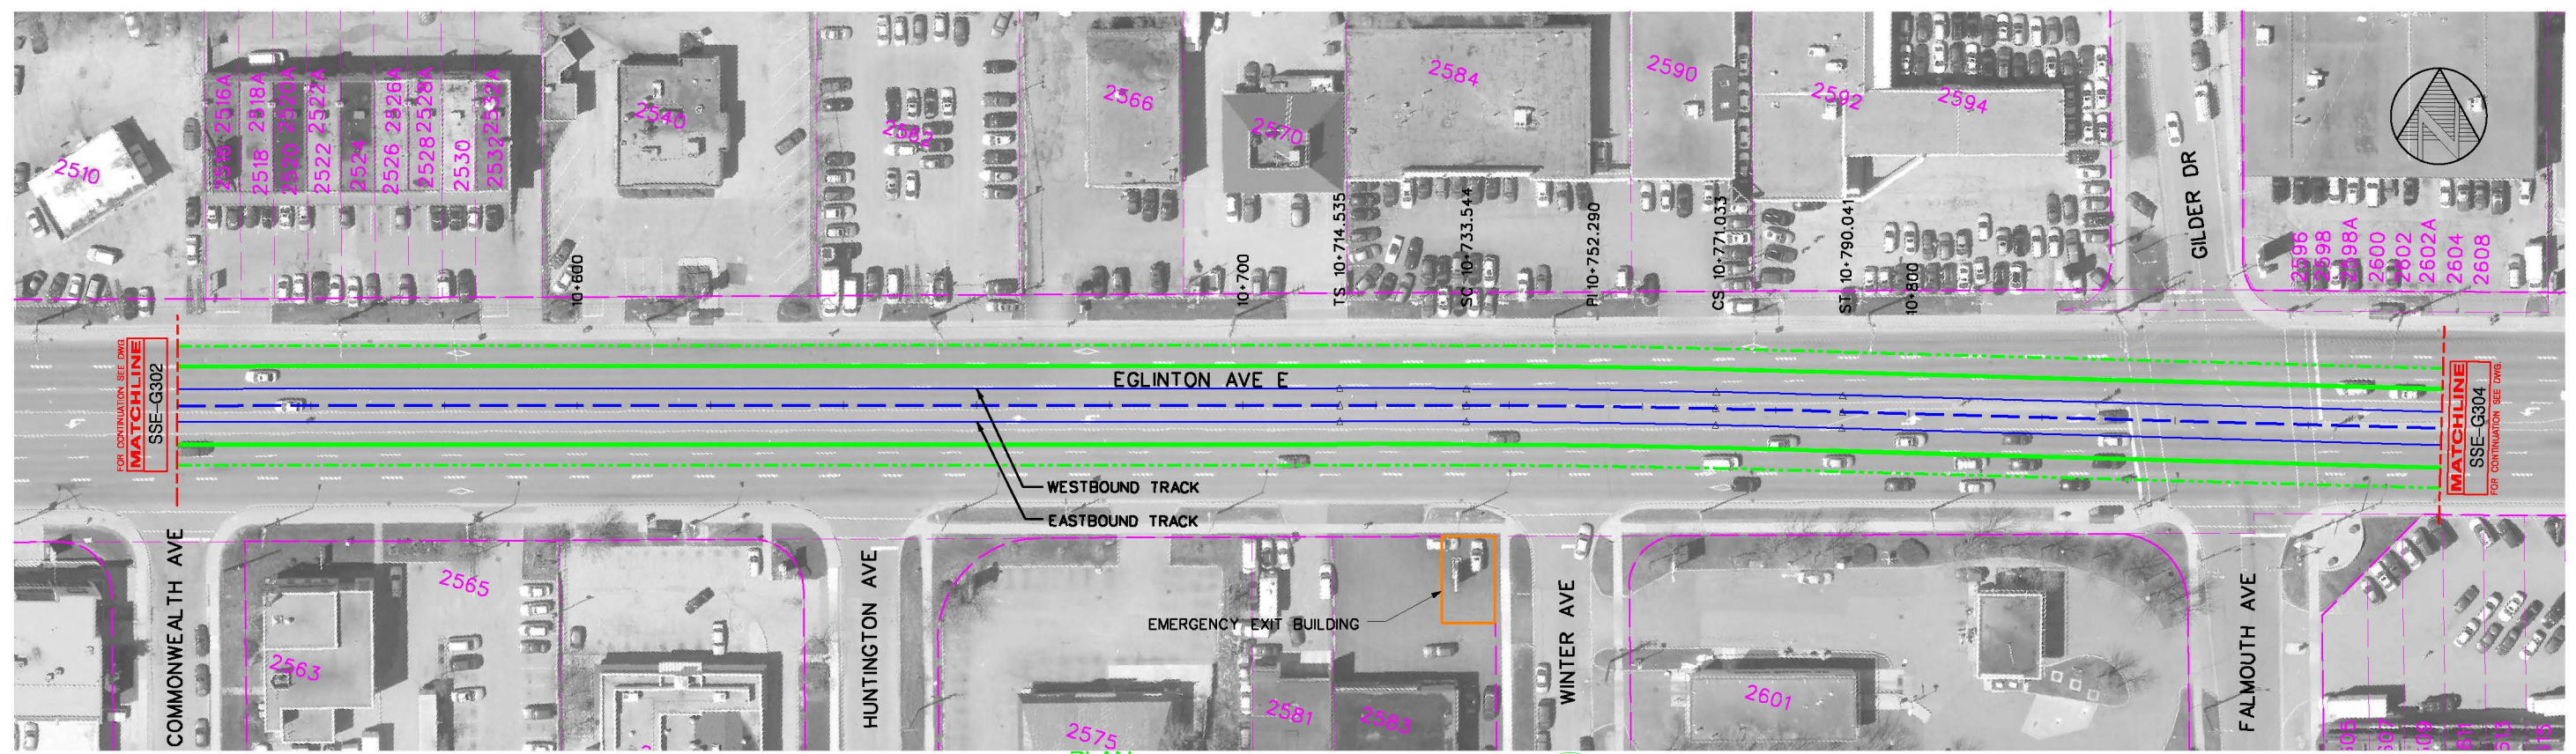

PLAN
STA 10+540 TO STA 10+880

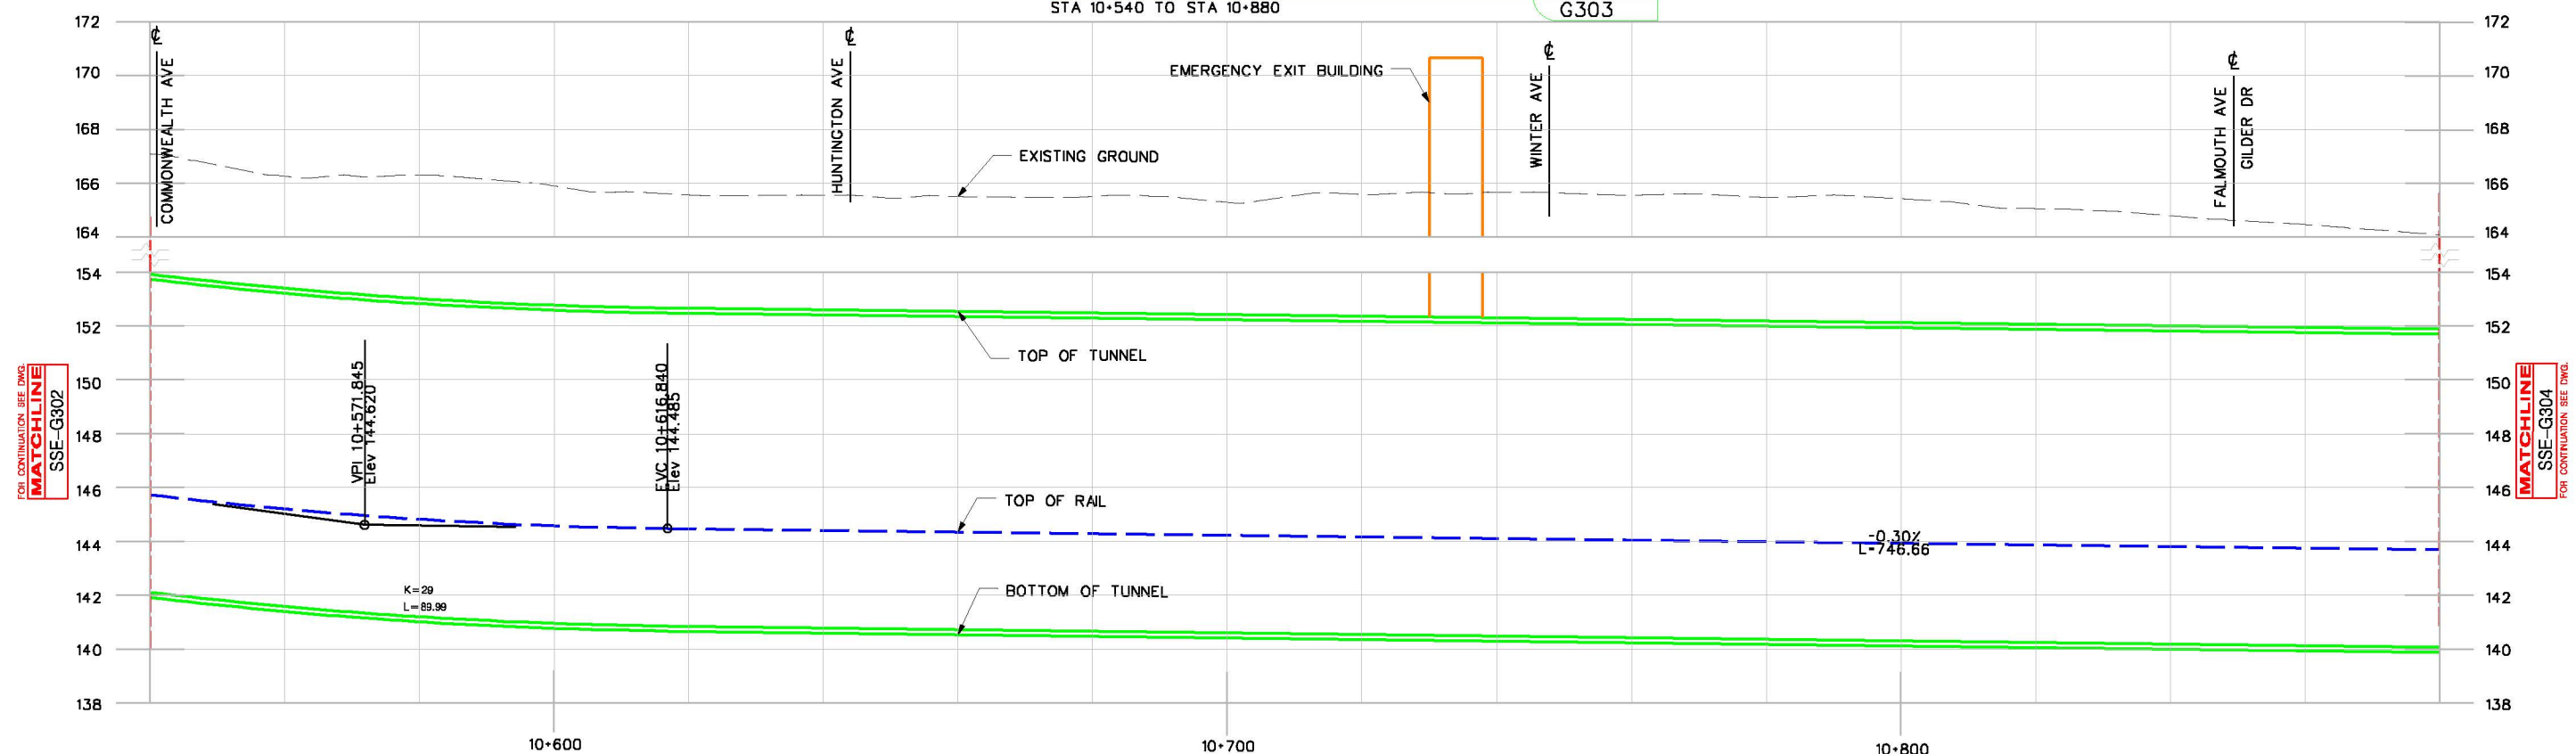

ELEVATION
STA 10+540 TO STA 10+880

REVISIONS

LEGEND	
	STRUCTURE
	ALIGNMENT
	NEW TTC RIGHT-OF-WAY
	TRACK
	EXISTING PROPERTY LINE
	EMERGENCY EXIT BUILDING (EEB)
	TRACTION POWER SUBSTATION




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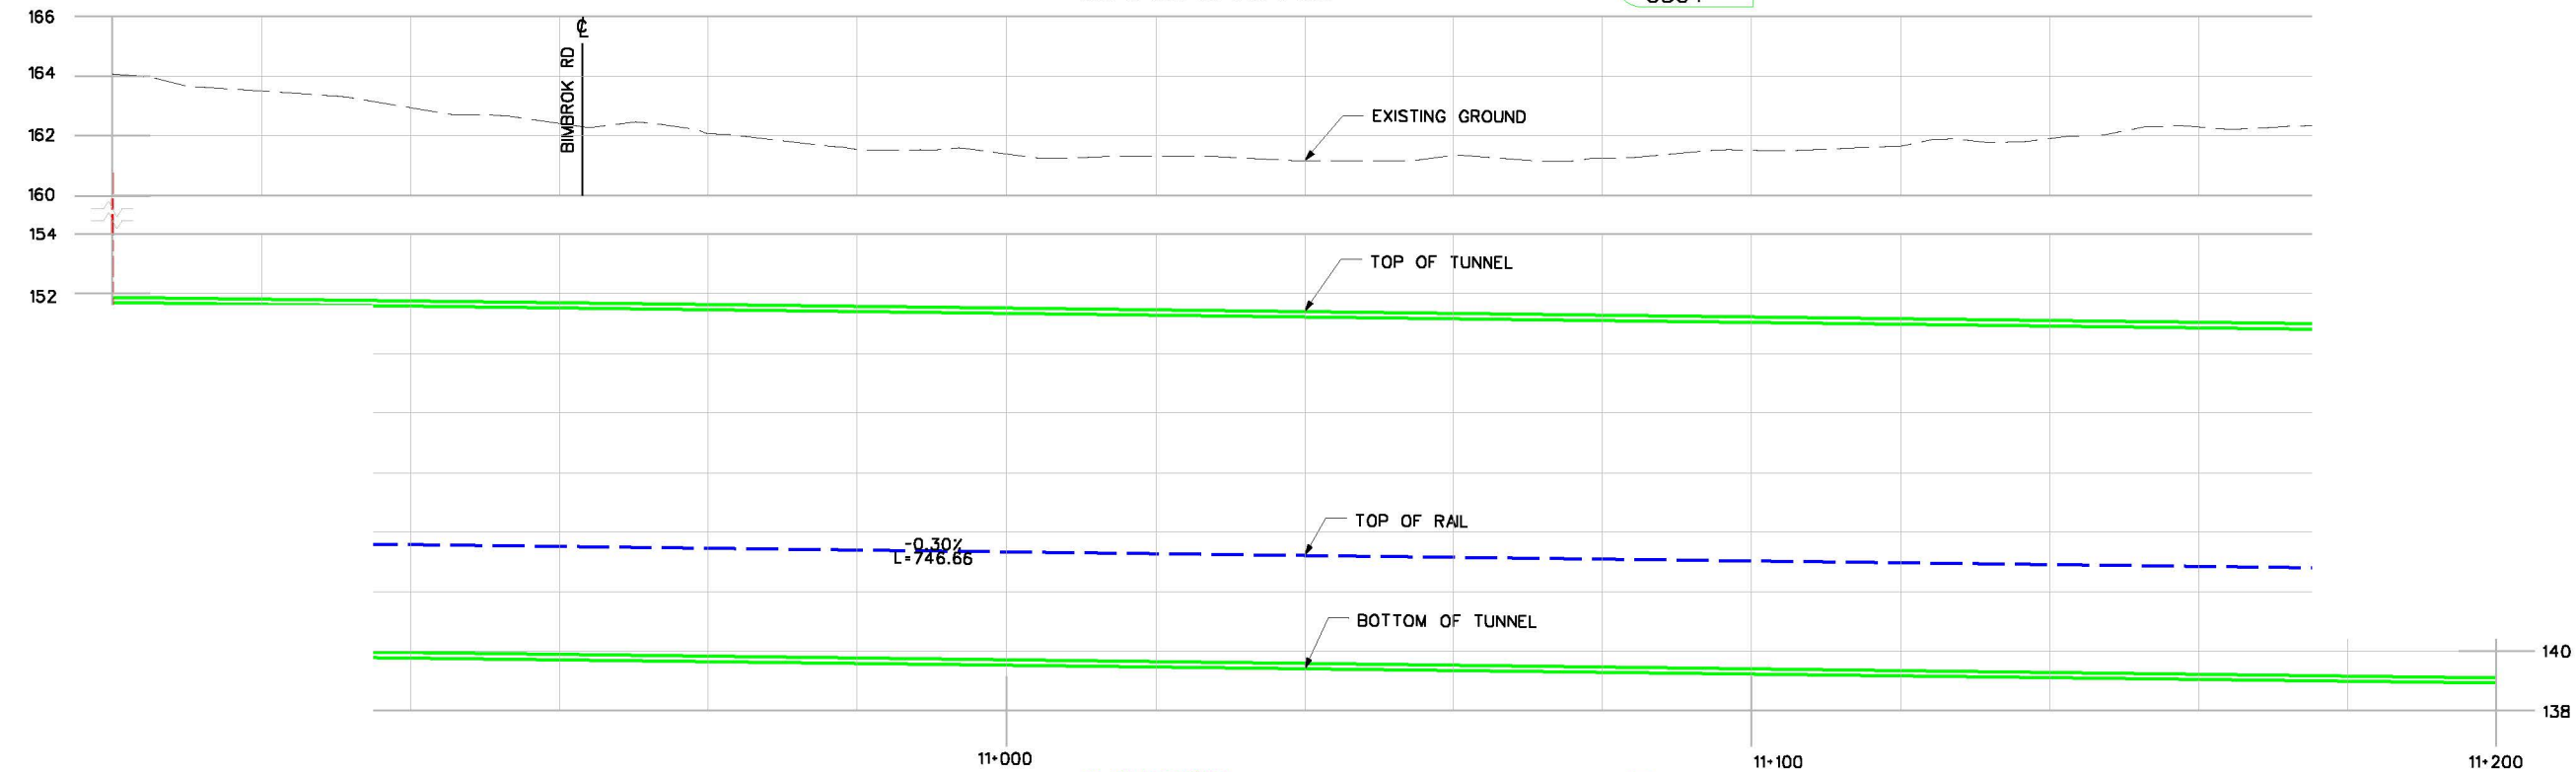
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SCARBOROUGH SUBWAY EXTENSION EA
PLAN AND PROFILE
STA 10+540 TO STA 10+880

Plot Date:	3/9/2017
TORONTO TRANSIT COMMISSION ENGINEERING DEPARTMENT	
Dwg. No.	SSE-G303
Sheet No.	



PLAN
STA 10+880 TO STA 11+200
1
G304

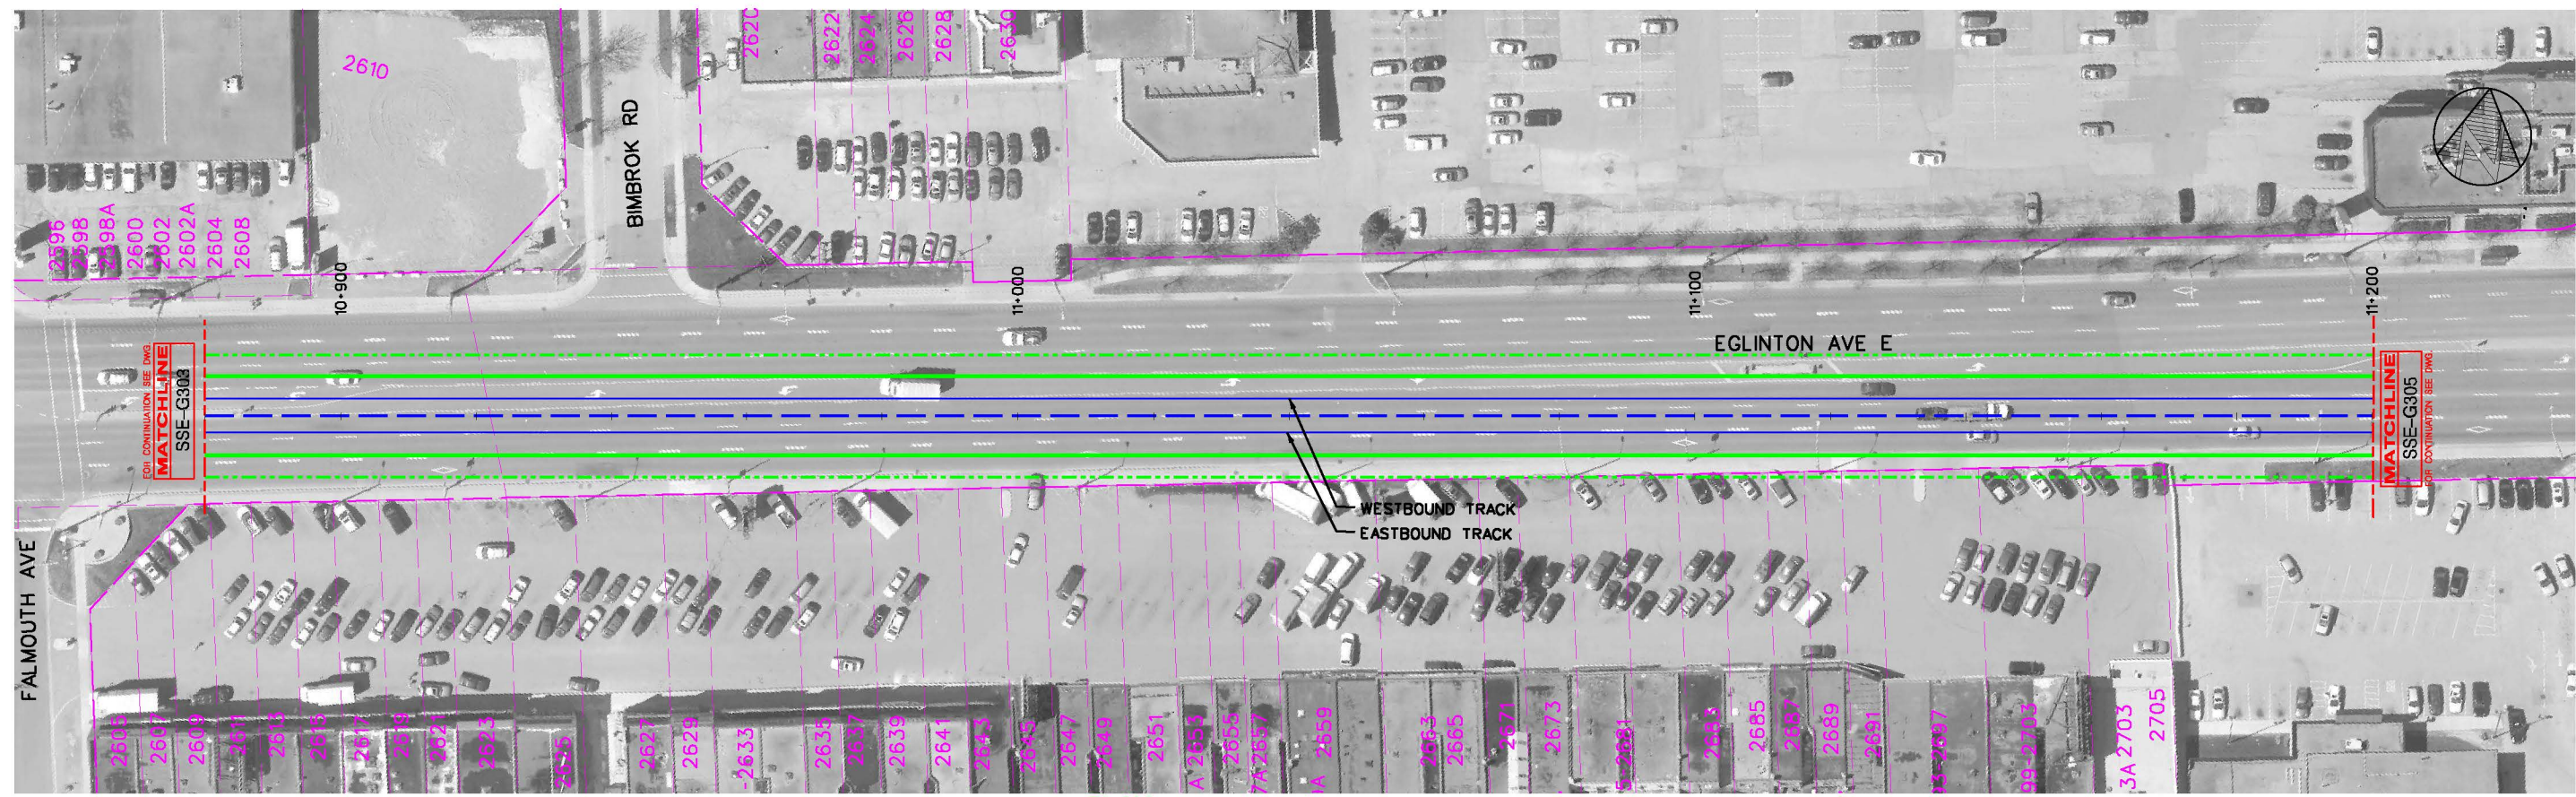

ELEVATION
STA 10+880 TO STA 11+200
1
G304

EMERGENCY EXIT BUILDING (EEB)



CONCEPTUAL DESIGN

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CHECKED	D.F. ANG	2017/02/28
CORRECT	D.F. ANG	2017/02/28
SCALE	HOR: 0 10 20 30 40m - 1:1000 VER: 0 5 10m - 1:250	

SCARBOROUGH SUBWAY EXTENSION EA
PLAN AND PROFILE
STA 10+880 TO STA 11+200

Plot Date:	3/9/2017
TORONTO TRANSIT COMMISSION ENGINEERING DEPARTMENT	
Dwg. No.	SSE-G304
Sheet No.	


engborc3.dgn (BORDEF) JULY 2, 2013

BLDG. REF. No.


FILENAME:

SHEET No.

DRAWING No.

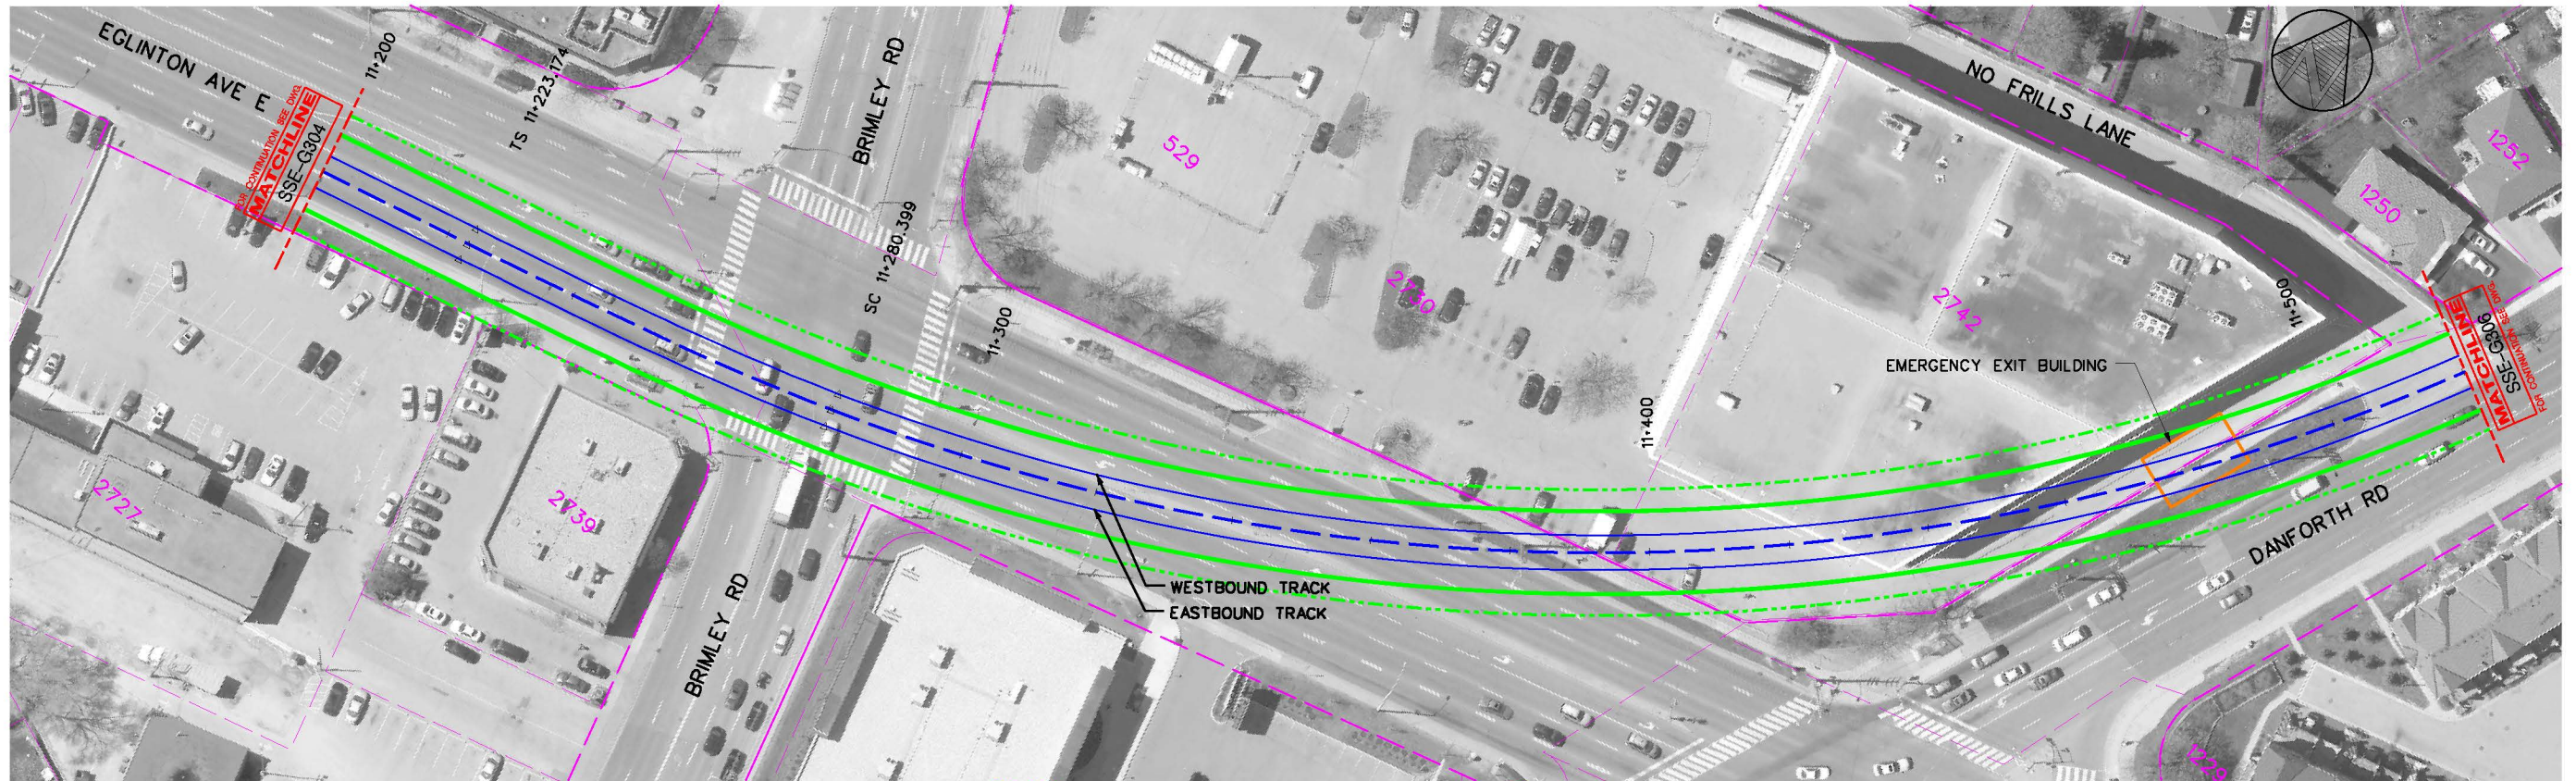

PLAN
STA 11+200 TO STA 11+520
1
G305

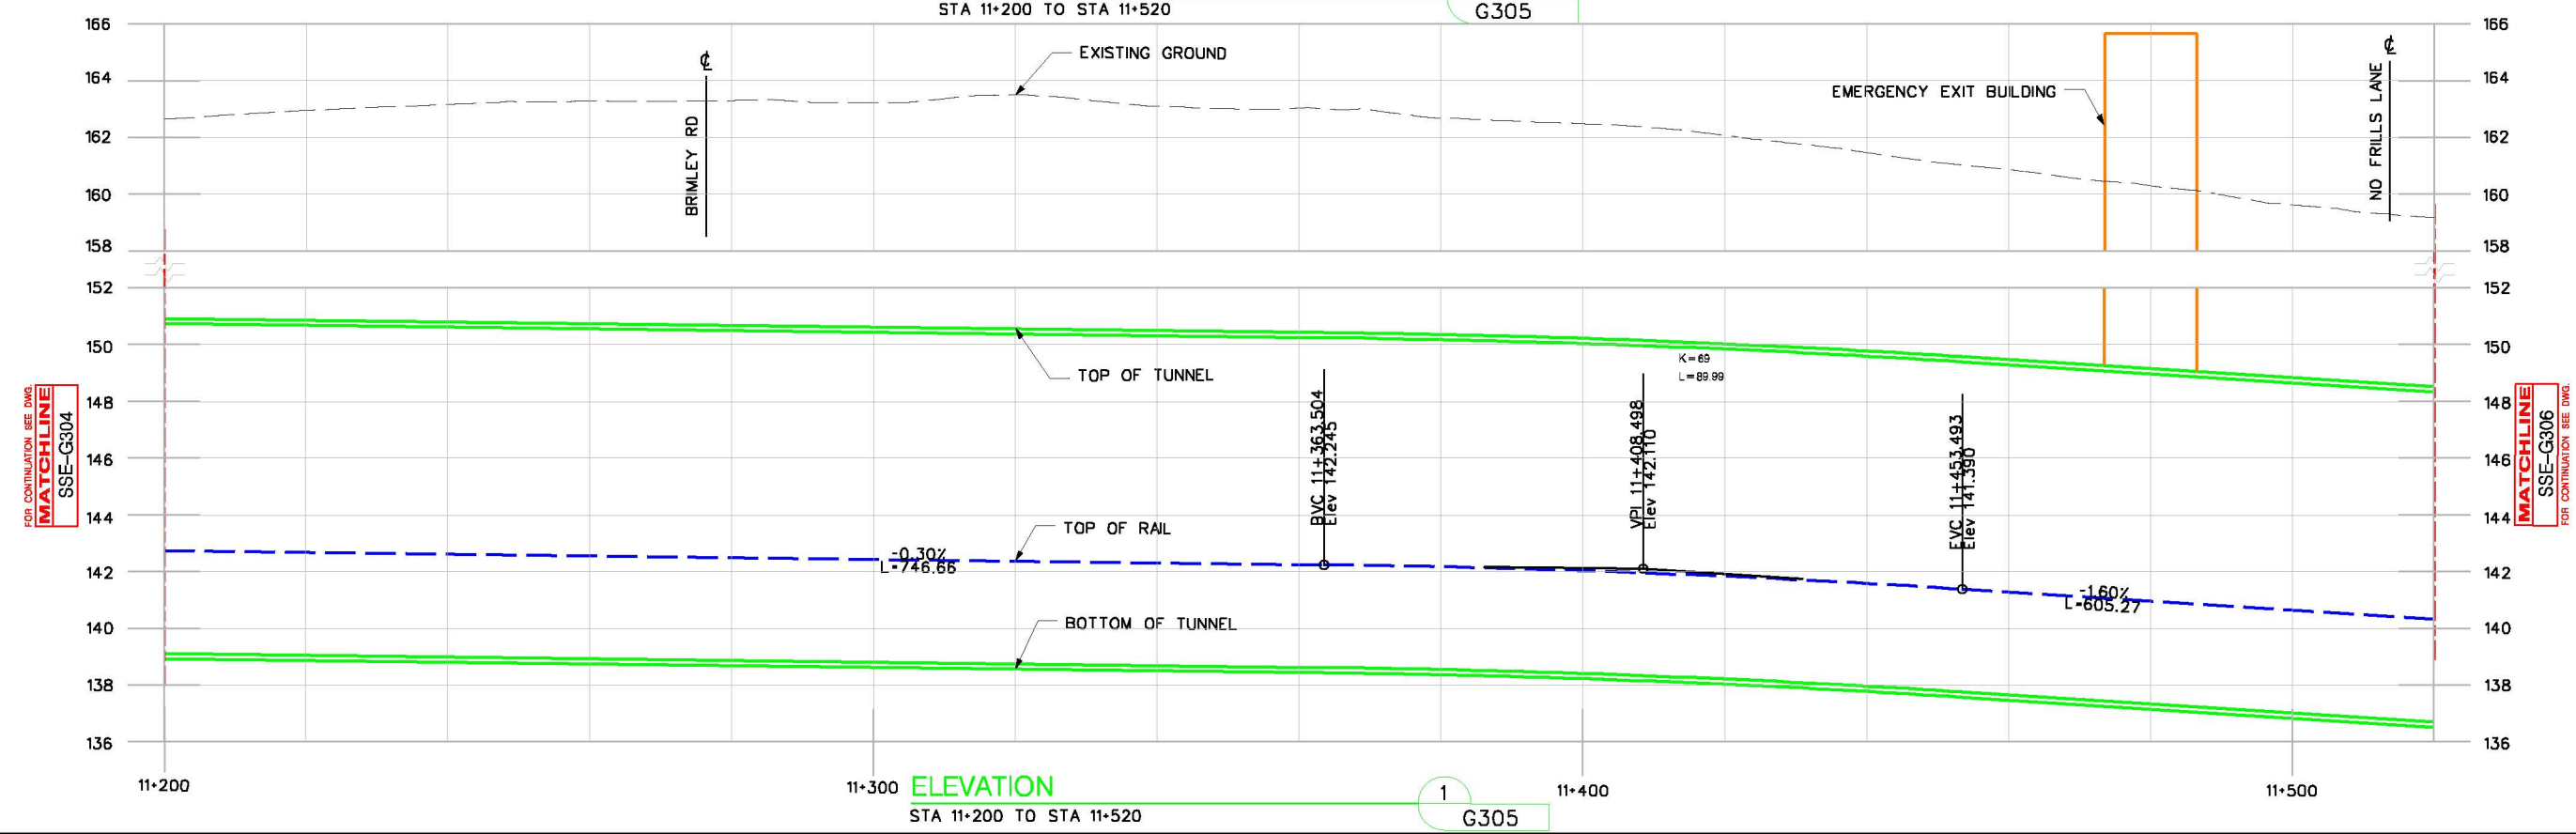

ELEVATION
STA 11+200 TO STA 11+520
1
G305

REVISIONS

LEGEND	
	STRUCTURE
	ALIGNMENT ϕ
	NEW TTC RIGHT-OF-WAY
	TRACK ϕ
	EXISTING PROPERTY LINE
	EMERGENCY EXIT BUILDING (EEB)
	TRACTION POWER SUBSTATION



CONCEPTUAL DESIGN
NOT FOR CONSTRUCTION

DRAWN	L. LI	2017/02/28
CHECKED	D. FANG	2017/02/28
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SCARBOROUGH SUBWAY EXTENSION EA
PLAN AND PROFILE
STA 11+200 TO STA 11+520

Plot Date:	3/9/2017
TORONTO TRANSIT COMMISSION ENGINEERING DEPARTMENT	
Dwg. No.	SSE-G305
Sheet No.	


ENGINEER: J. BORDEN, JULY 2, 2015

BLDG. REF. No.


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SHEET No.

DRAWING No.

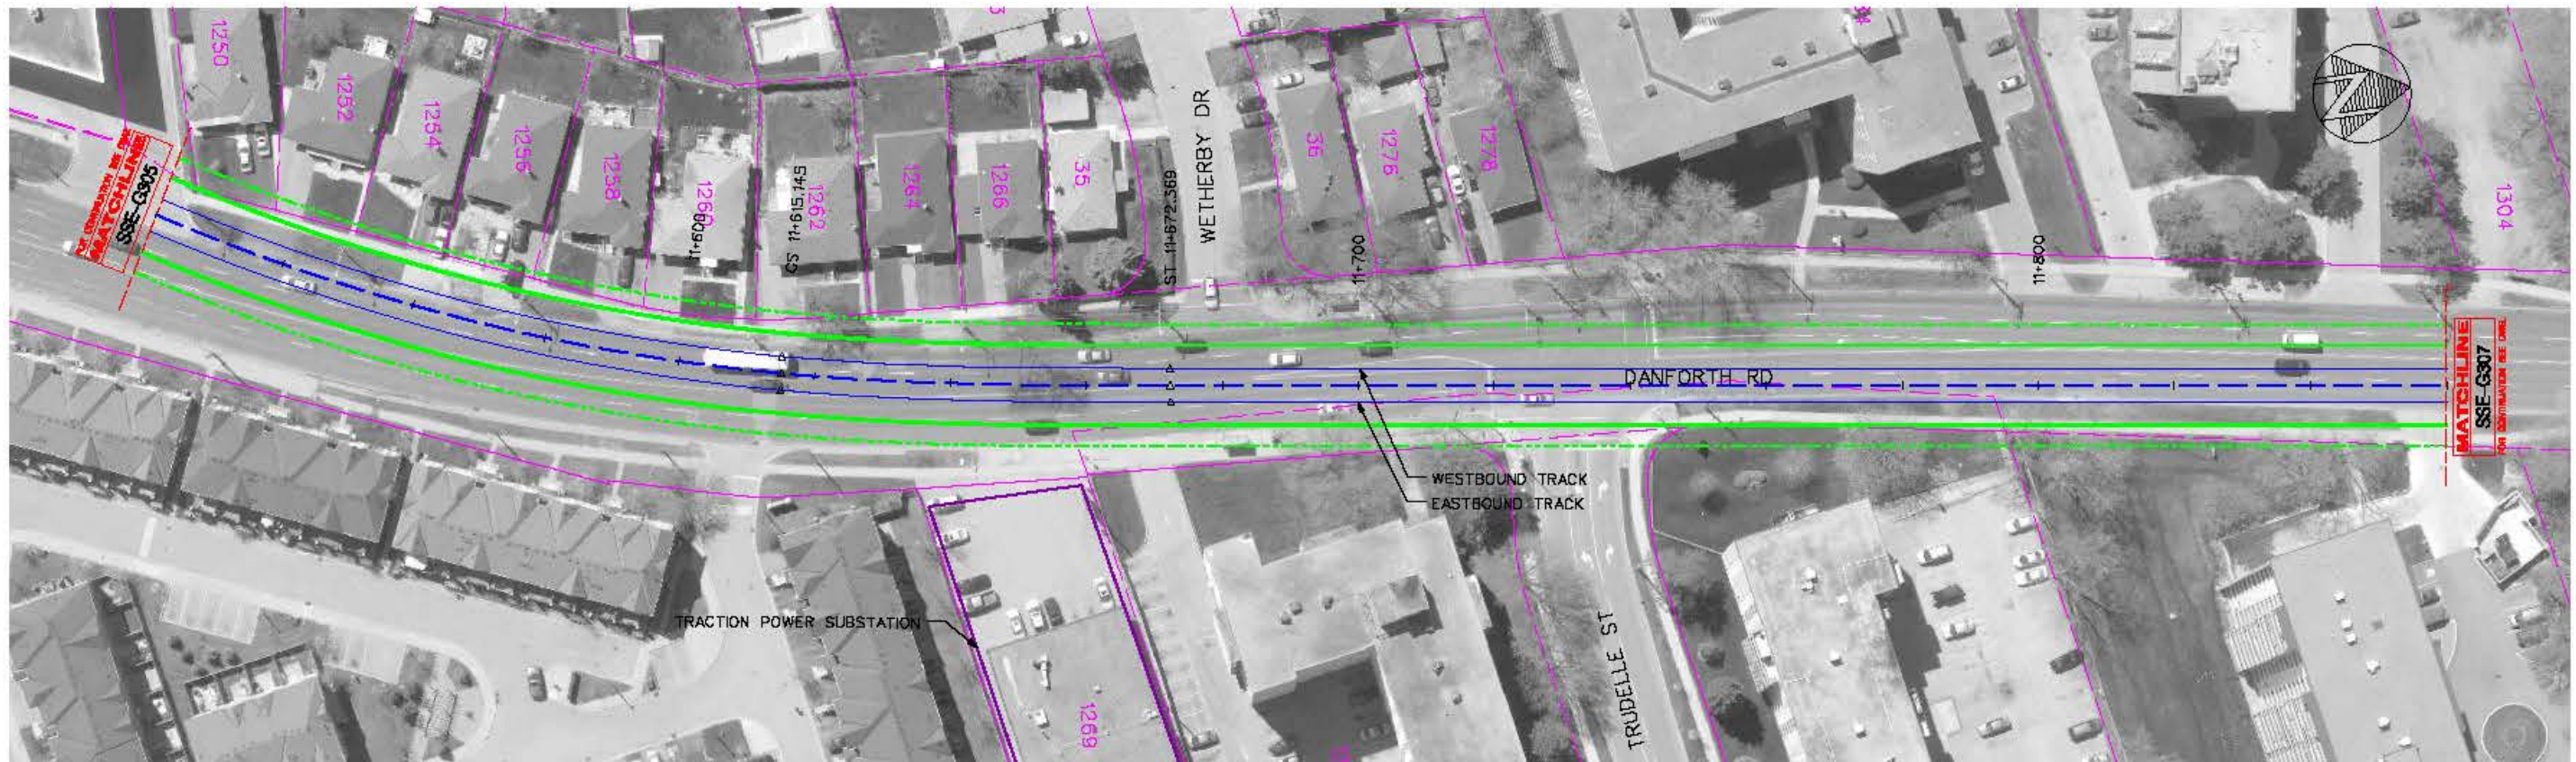

PLAN
STA 11+520 TO STA 11+840
1 G306

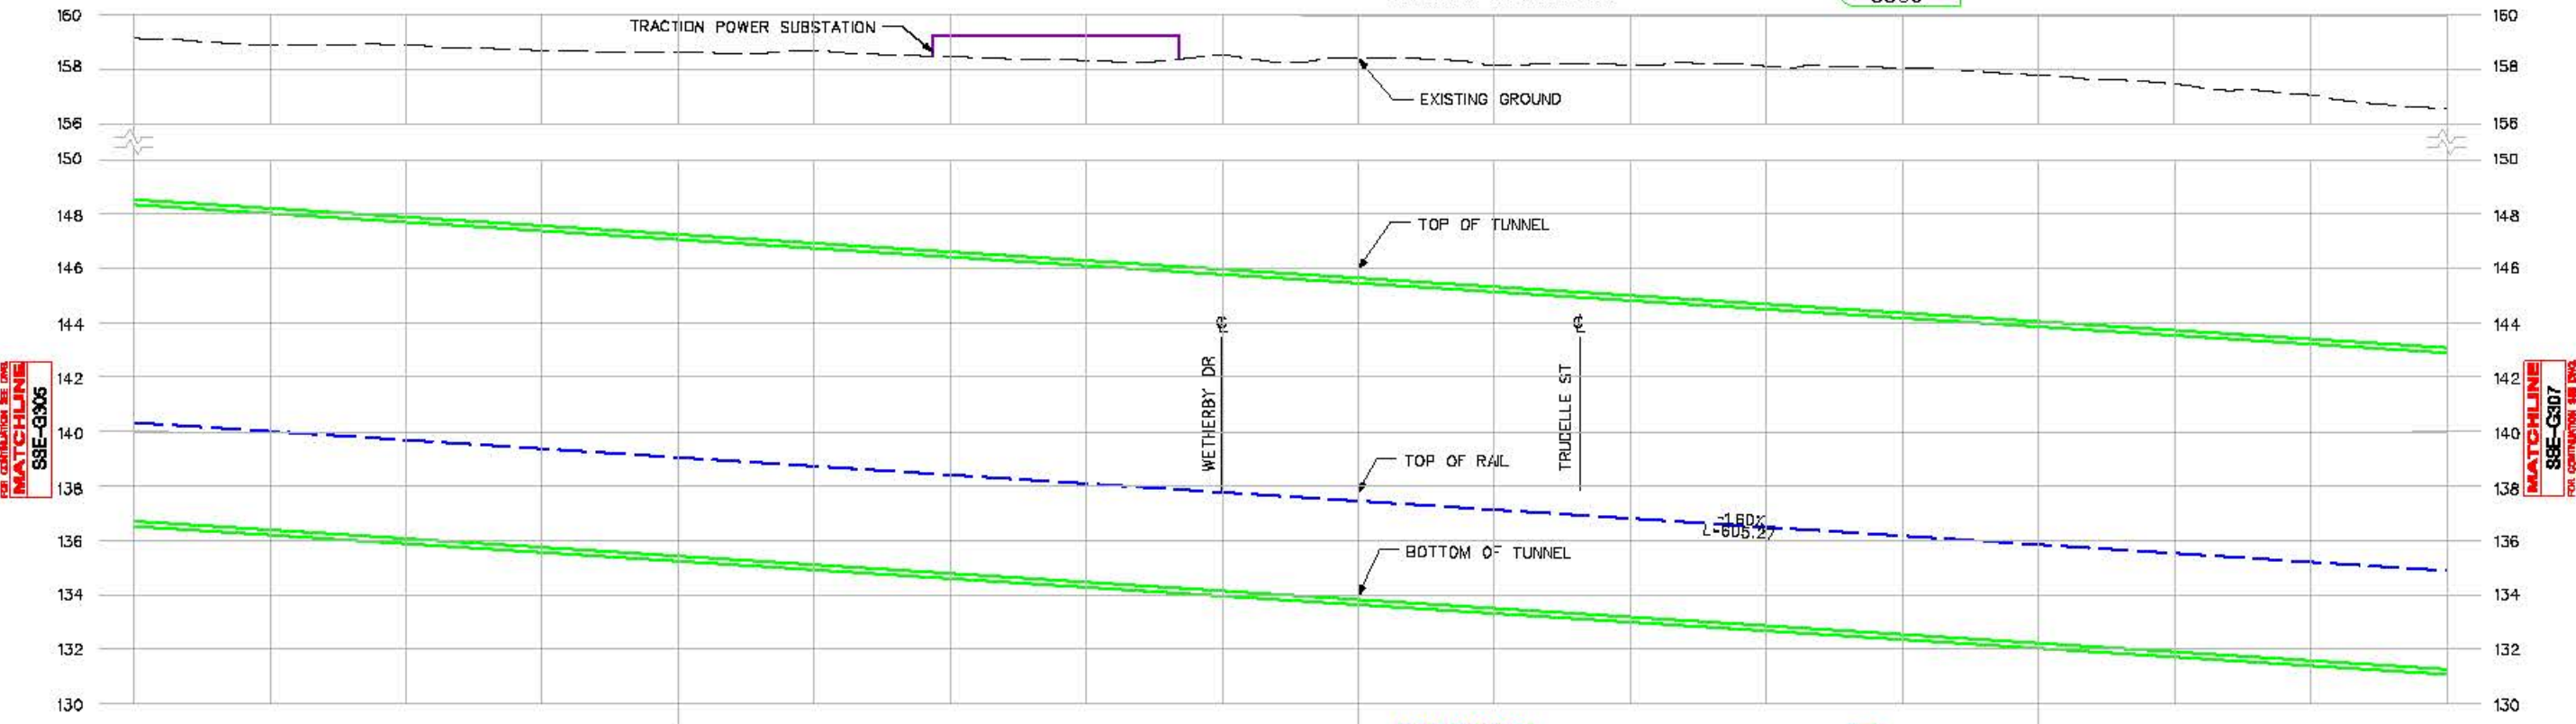

ELEVATION
STA 11+520 TO STA 11+840
1 G306

REVISIONS

LEGEND	
	STRUCTURE
	ALIGNMENT
	NEW TTC RIGHT-OF-WAY
	TRACK
	EXISTING PROPERTY LINE
	EMERGENCY EXIT BUILDING (EEB)
	TRACTION POWER SUBSTATION



CONCEPTUAL DESIGN
NOT FOR CONSTRUCTION

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CORRECT	D.F.A.N.G.	2017/02/28	
SCALE	HOR	1" = 100'	
SCALE	VER	1" = 1250'	

SCARBOROUGH SUBWAY EXTENSION EA
PLAN AND PROFILE
STA 11+520 TO STA 11+860

Plot Date	7/20/2017
TORONTO TRANSIT COMMISSION ENGINEERING DEPARTMENT	
Dep. No.	SSE-G306
Sheet No.	



PLAN
STA 11+840 TO STA 12+200

1
G307



ELEVATION
STA 11+840 TO STA 12+200

1
G307

NO.	REVISIONS

LEGEND	
	STRUCTURE
	ALIGNMENT ϕ
	NEW TTC RIGHT-OF-WAY
	TRACK ϕ
	EXISTING PROPERTY LINE
	EMERGENCY EXIT BUILDING (EEB)
	TRACTION POWER SUBSTATION




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SCALE	HORIZ - 1/1000		
VER	VERT - 1/250		

SCARBOROUGH SUBWAY EXTENSION EA
PLAN AND PROFILE
STA 11+860 TO STA 12+200

File Date	2/28/2017
TORONTO TRANSIT COMMISSION ENGINEERING DEPARTMENT	
Draw No.	SSE-G307
Sheet No.	

engineers.dgn (BORDBY JULY 2, 2015)

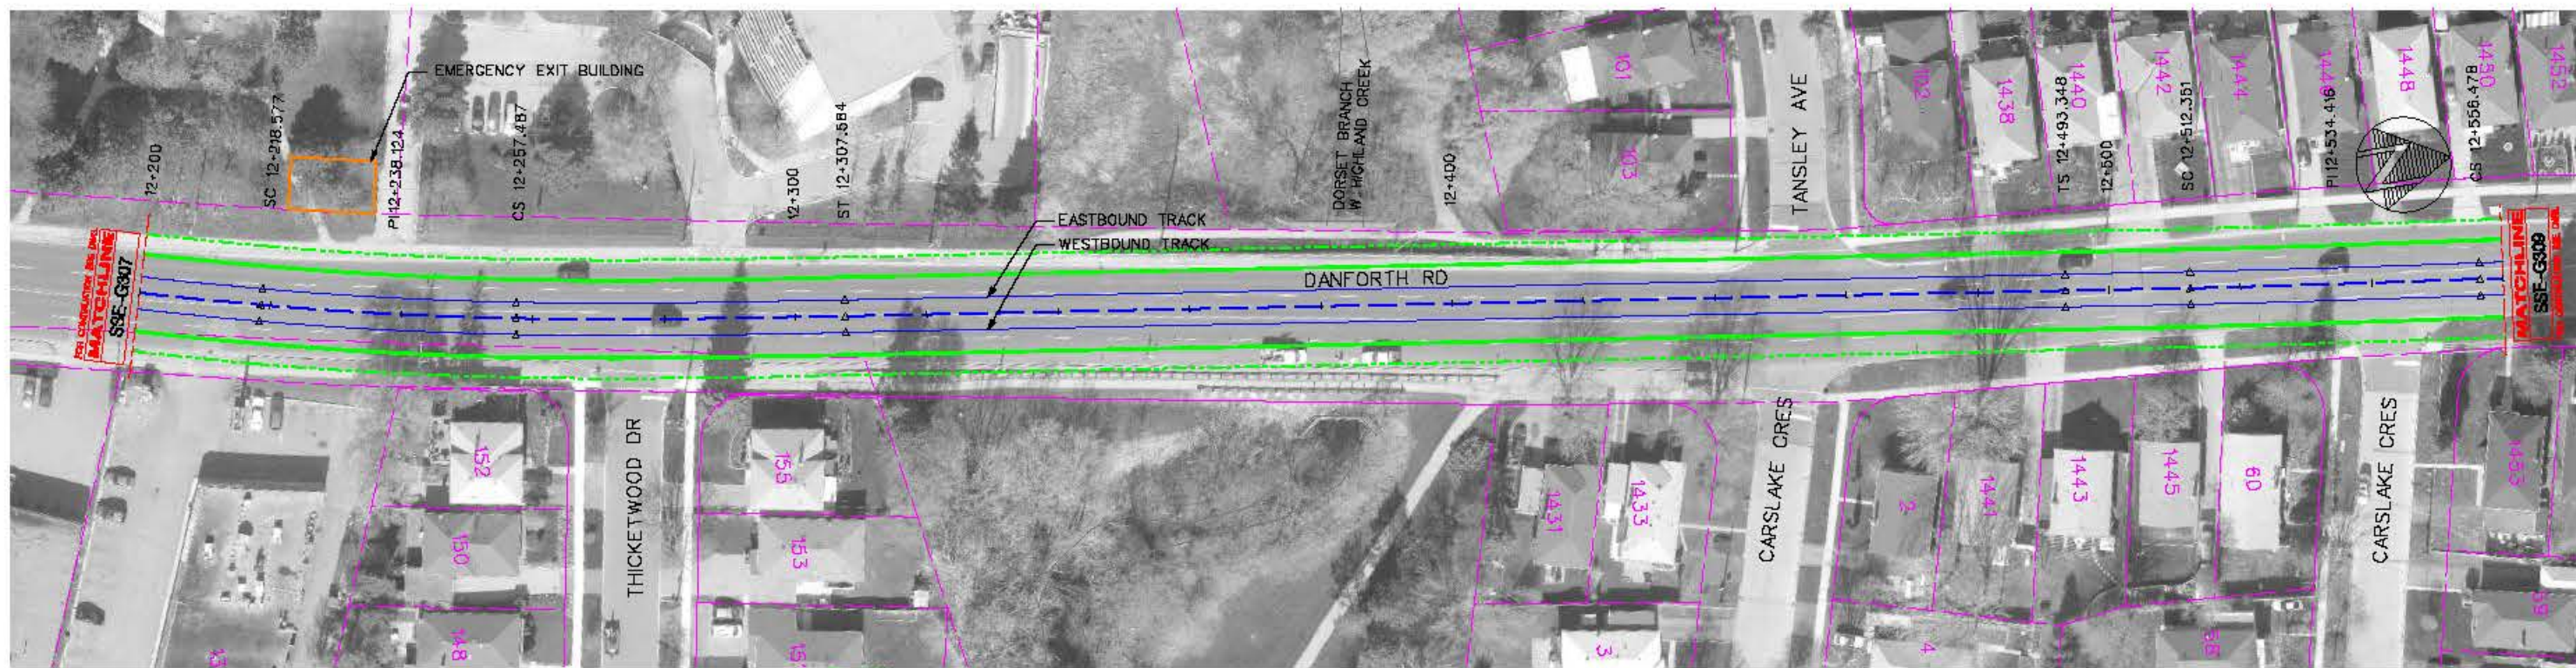

PLAN
STA 12+200 TO STA 12+560



ELEVATION
STA 12+200 TO STA 12+560

BLDG. REF. No.

FILENAME:

SHEET No.

DRAWING No.

FOR CONTINUATION SEE DRAWING
MATCHLINE
SSE-G307

MATCHLINE
SSE-G309
FOR CONTINUATION SEE DRAWING

NO.	REVISIONS

LEGEND	
	STRUCTURE
	ALIGNMENT
	NEW TTC RIGHT-OF-WAY
	TRACK
	EXISTING PROPERTY LINE
	EMERGENCY EXIT BUILDING (EEB)
	TRACTION POWER SUBSTATION



CONCEPTUAL DESIGN
NOT FOR CONSTRUCTION


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SCARBOROUGH SUBWAY EXTENSION EA


PLAN AND PROFILE

STA 12+200 TO STA 12+560

File Date	7/29/2017
TORONTO TRANSIT COMMISSION ENGINEERING DEPARTMENT	
Dep. No.	SSE-G308
Sheet No.	

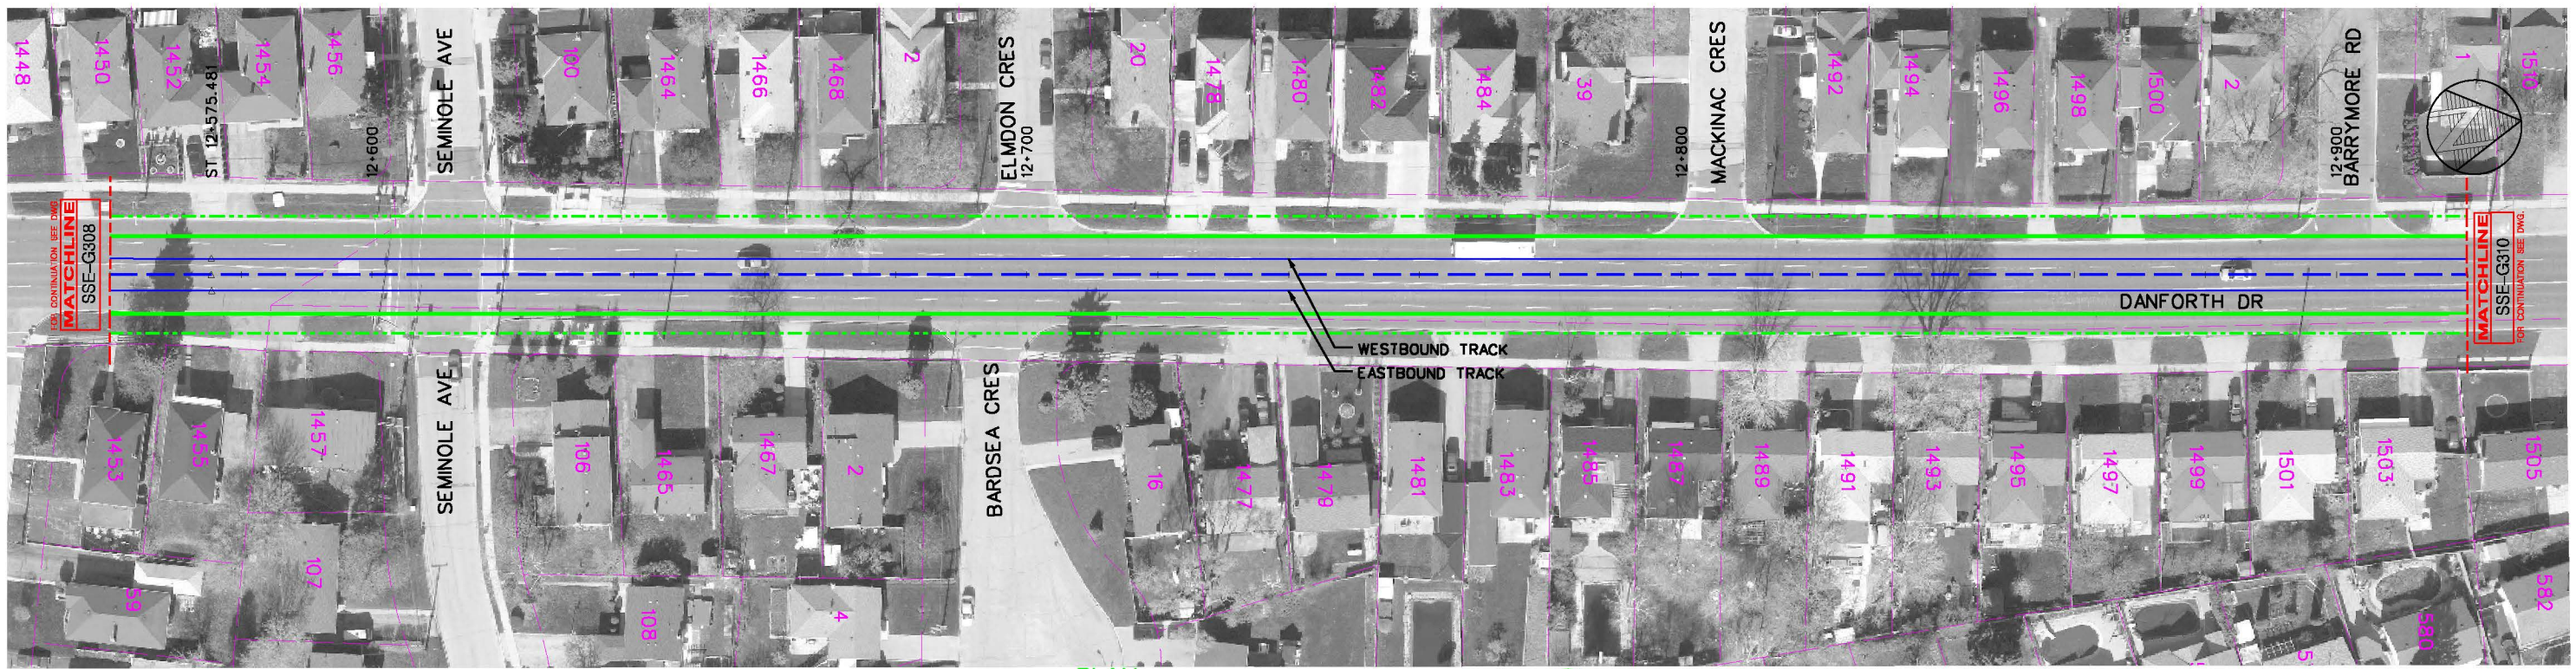

PLAN
 STA 12+560 STA 12+920
 1 G309

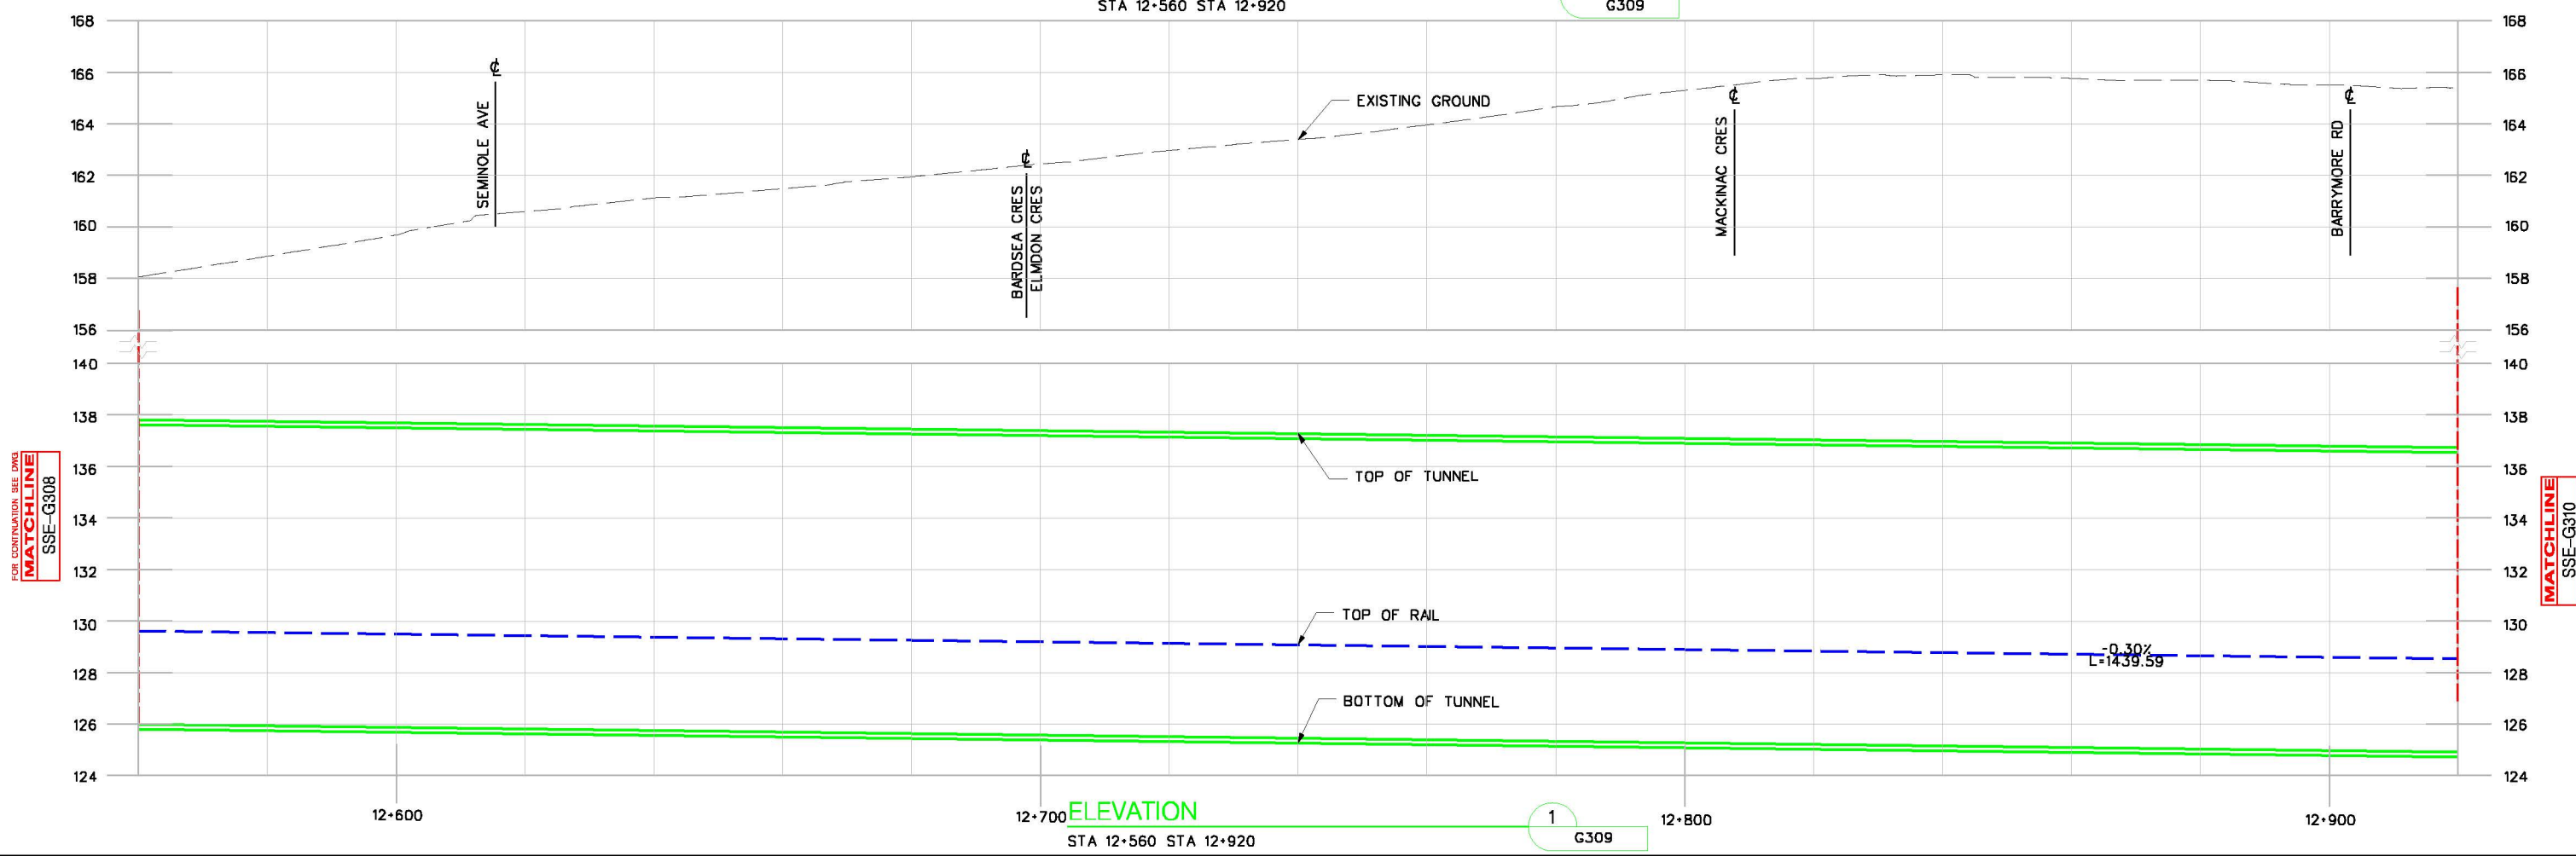

ELEVATION
 STA 12+560 STA 12+920
 1 G309

BUDG. REF. No.

FILENAME:

SHEET No.

DRAWING No.

REVISIONS

LEGEND	
	STRUCTURE
	ALIGNMENT ϕ
	NEW TTC RIGHT-OF-WAY
	TRACK ϕ
	EXISTING PROPERTY LINE
	EMERGENCY EXIT BUILDING (EEB)
	TRACTION POWER SUBSTATION



CONCEPTUAL DESIGN
 NOT FOR CONSTRUCTION

DRAWN	L. LI	2017/02/28
CHECKED	D. FANG	2017/02/28
CORRECT	D. FANG	2017/02/28
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SCARBOROUGH SUBWAY EXTENSION EA
PLAN AND PROFILE
 STA 12+560 STA 12+920

Plot Date:	3/9/2017
 TORONTO TRANSIT COMMISSION ENGINEERING DEPARTMENT	
Dwg. No.	SSE-G309
Sheet No.	